

IDAHO DEPARTMENT OF JUVENILE CORRECTIONS

JUVENILE CORRECTIONS CENTER NAMPA - LAUNDRY, KITCHEN & CLINIC REMODEL

DIVISION OF PUBLIC WORKS PROJECT #21535

1650 11TH AVE. NORTH, NAMPA, IDAHO 83687

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OCTOBER 13, 2022

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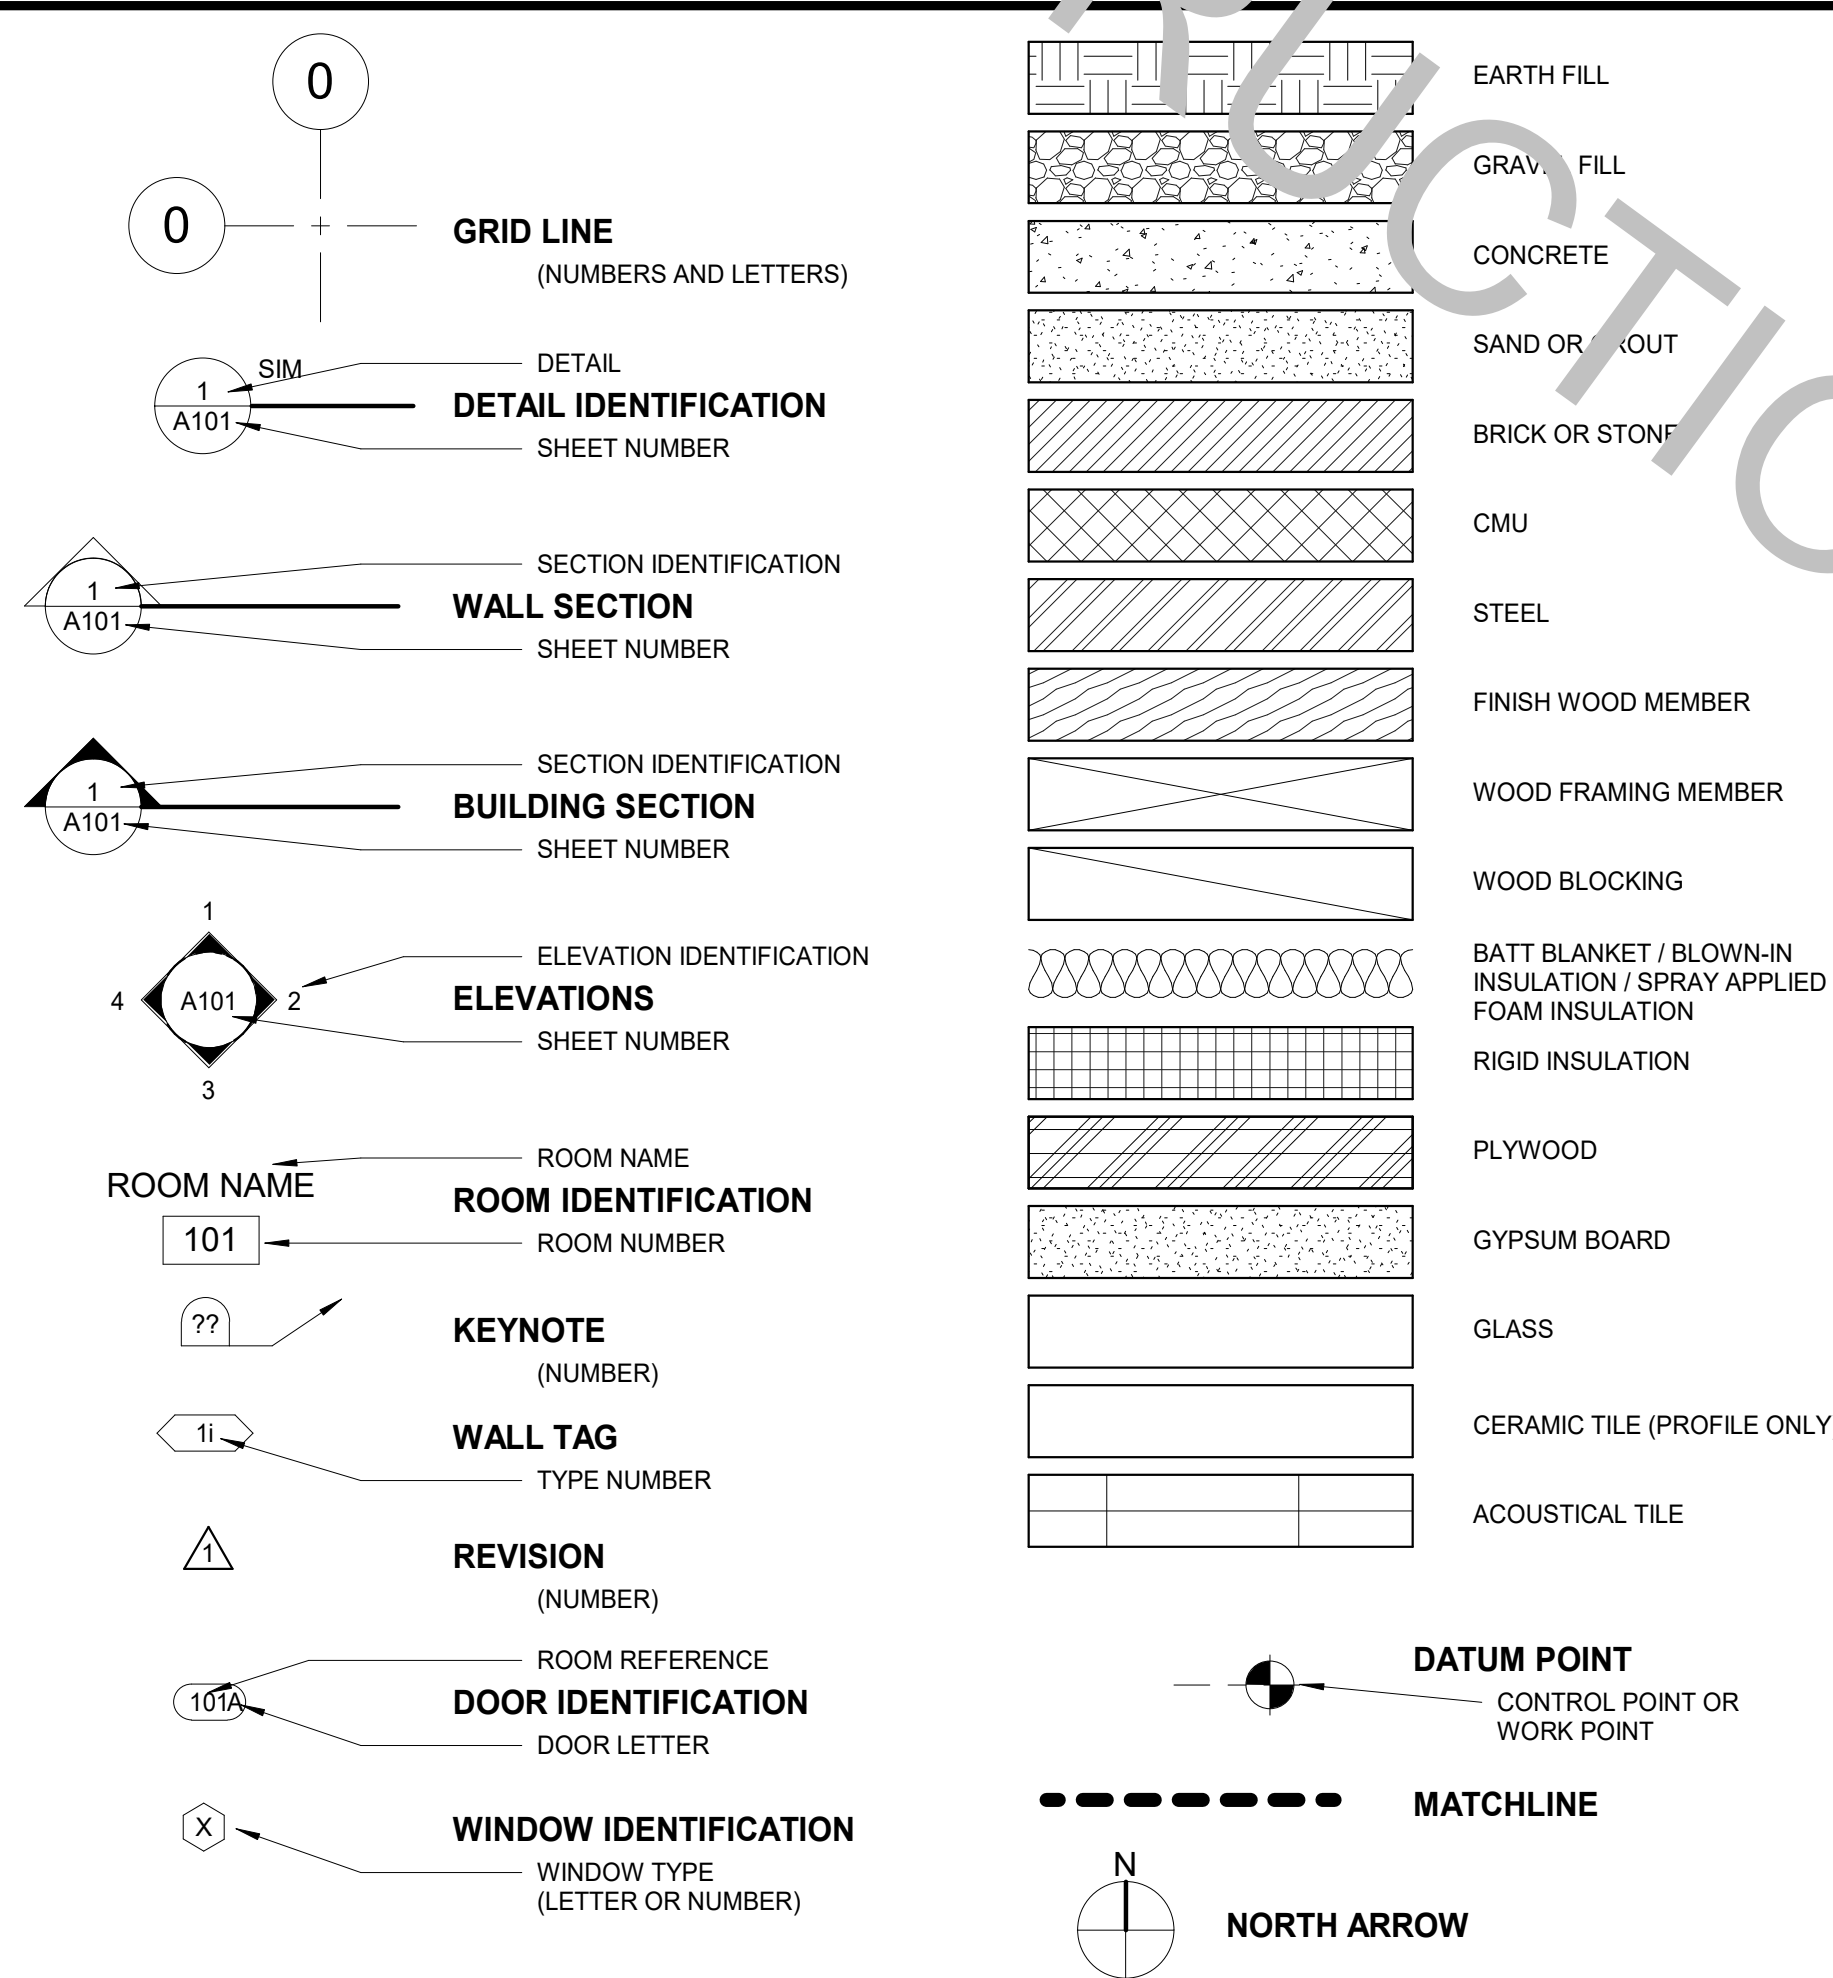
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ABBREVIATIONS

A-E	F-M	N-R	S-Z
A.B. ANCHOR BOLT ACOUS. ACOUSTICAL ADJ. ADJUSTABLE A.F.F. ABOVE FINISH FLOOR AGGR. AGGREGATE AL. ALUMINUM APPROX. APPROXIMATE ARCH. ARCHITECTURAL	F.A. FIRE ALARM F.D. FLOOR DRAIN F.E. FIRE EXTINGUISHER F.E.C. FIRE EXTINGUISHER CABINET FF. FACTORY FINISH F.H.C. FIRE HOSE CABINET FIN. FINISH FLR. FLOOR F.O.B. FACE OF BUILDING F.O.C. FACE OF CONCRETE F.O.E. FACE OF EXISTING F.O.F. FACE OF FINISH F.O.S. FACE OF STUDS FT. FEET/FOOT FTG. FOOTING FURR. FURRING	N/C. NON-COMBUSTIBLE N.I.C. NOT IN CONTRACT NO. NUMBER NOM. NOMINAL N.T.S. NOT TO SCALE O.A. OVERALL O.C. ON CENTER O.D. OUTSIDE DIAMETER O.F.C.I. OWNER FURNISHED/ CONTRACTOR- INSTALLED O.F.O.I. OWNER FURNISHED/ OWNER INSTALLED OFF. OFFICE OPNG. OPENING OPP. OPPOSITE PL. PLATE PL. PLASTIC LAMINATE PLAS. PLASTER PLYWD. PLYWOOD PR. PAIR PT. POINT P.T.D. PAPER TOWEL DISPENSER P.T.R. PAPER TOWEL RECEPTACLE Q.T. QUARRY TILE RAD. RADIUS R.D. ROOF DRAIN REF. REFRIGERATOR REFR. REINFORCED REQ. REQUIRED RESIL. RESILIENT RM. ROOM R.O. ROUGH OPENING RAIN WATER LEADER	S.C. SOLID CORE SECT. SECTION SHT'G. SHEATHING SHT. SHEET SIM. SIMILAR SPEC. SPECIFICATION SQ. SQUARE S.S. STAINLESS STEEL STA. STATION STD. STANDARD STL. STEEL STOR. STORAGE STRL. STRUCTURAL SUSP. SUSPENDED T.C. TOP OF CURB TEL. TELEPHONE T.O. TOP OF T.O.B. TOP OF BLOCK T.O.C. TOP OF CURB T.O.P. TOP OF PLATE T.O.W. TOP OF WALL TRD. TREAD T.V. TELEVISION TYP. TYPICAL U.O.N. UNLESS OTHERWISE NOTED UR. URINAL VERT. VERTICAL VEST. VESTIBULE W/ WITHOUT W/O. WITHOUT W.C. WATER CLOSET WD. WOOD W.P. WATERPROOF W.R. WATER RESISTANT WT. WEIGHT
BD. BOARD BITUM. BITUMINOUS BLDG. BUILDING BLK. BLOCK BLKG. BLOCKING BOT. BOTTOM CAB. CABINET C.F.O.I. CONTRACTOR- FURNISHED/OWNER- INSTALLED C.L. CENTERLINE CLG. CEILING CLR. CLEAR C.M.U. CONCRETE MASONRY UNIT COL. COLUMN CONC. CONCRETE CONN. CONNECTION CONT. CONTINUOUS CORR. CORRIDOR CTSK. COUNTERSUNK CNTR. COUNTER CTR. CENTER DBL. DOUBLE DEPT. DEPARTMENT D.F. DRINKING FOUNTAIN DET. DETAIL DIA. DIAMETER DIM. DIMENSION DISP. DISPENSER DN. DOWN EA. EACH E.I.F.S. EXTERIOR INSULATION AND FINISH SYSTEM E.J. ELECTRICAL ELEV. ELEVATION ELEV. ELEVATOR ENCL. ENCLOSURE EQ. EQUAL EQUIP. EQUIPMENT EXP. EXPANSION EXT. EXISTING EXT. EXTERIOR	GA. GAUGE GALV. GALVANIZED GND. GROUND GR. GRADE GYP. GYPSUM BOARD H.C. HOLLOW CORE HWD. HARDWOOD H.M. HOLLOW METAL HORIZ. HORIZONTAL HGT. HEIGHT I.D. INSIDE DIAMETER INSUL. INSULATION INT. INTERIOR JAN. JANITOR JT. JOINT KIT. KITCHEN LAB. LABORATORY LAV. LAVATORY MAX. MAXIMUM MECH. MECHANICAL MTL. METAL MFR. MANUFACTURER MH. MANHOLE MIN. MINIMUM MISC. MISCELLANEOUS M.O. MASONRY OPENING MTD. MOUNTED		

FOR ADDITIONAL MATERIAL FINISH
ABBREVIATIONS, SEE MATERIAL
LEGEND ON ROOM FINISH SHEETS.

GRAPHIC AND MATERIAL SYMBOLS



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VICINITY MAP

PROJECT SITE



NAMPA, IDAHO

APPROVAL AREA

MRK DATE DESCRIPTION


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COVER SHEET

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OVERALL PLAN

SHEET NO.


A1.0

DEMOLITION GENERAL NOTES

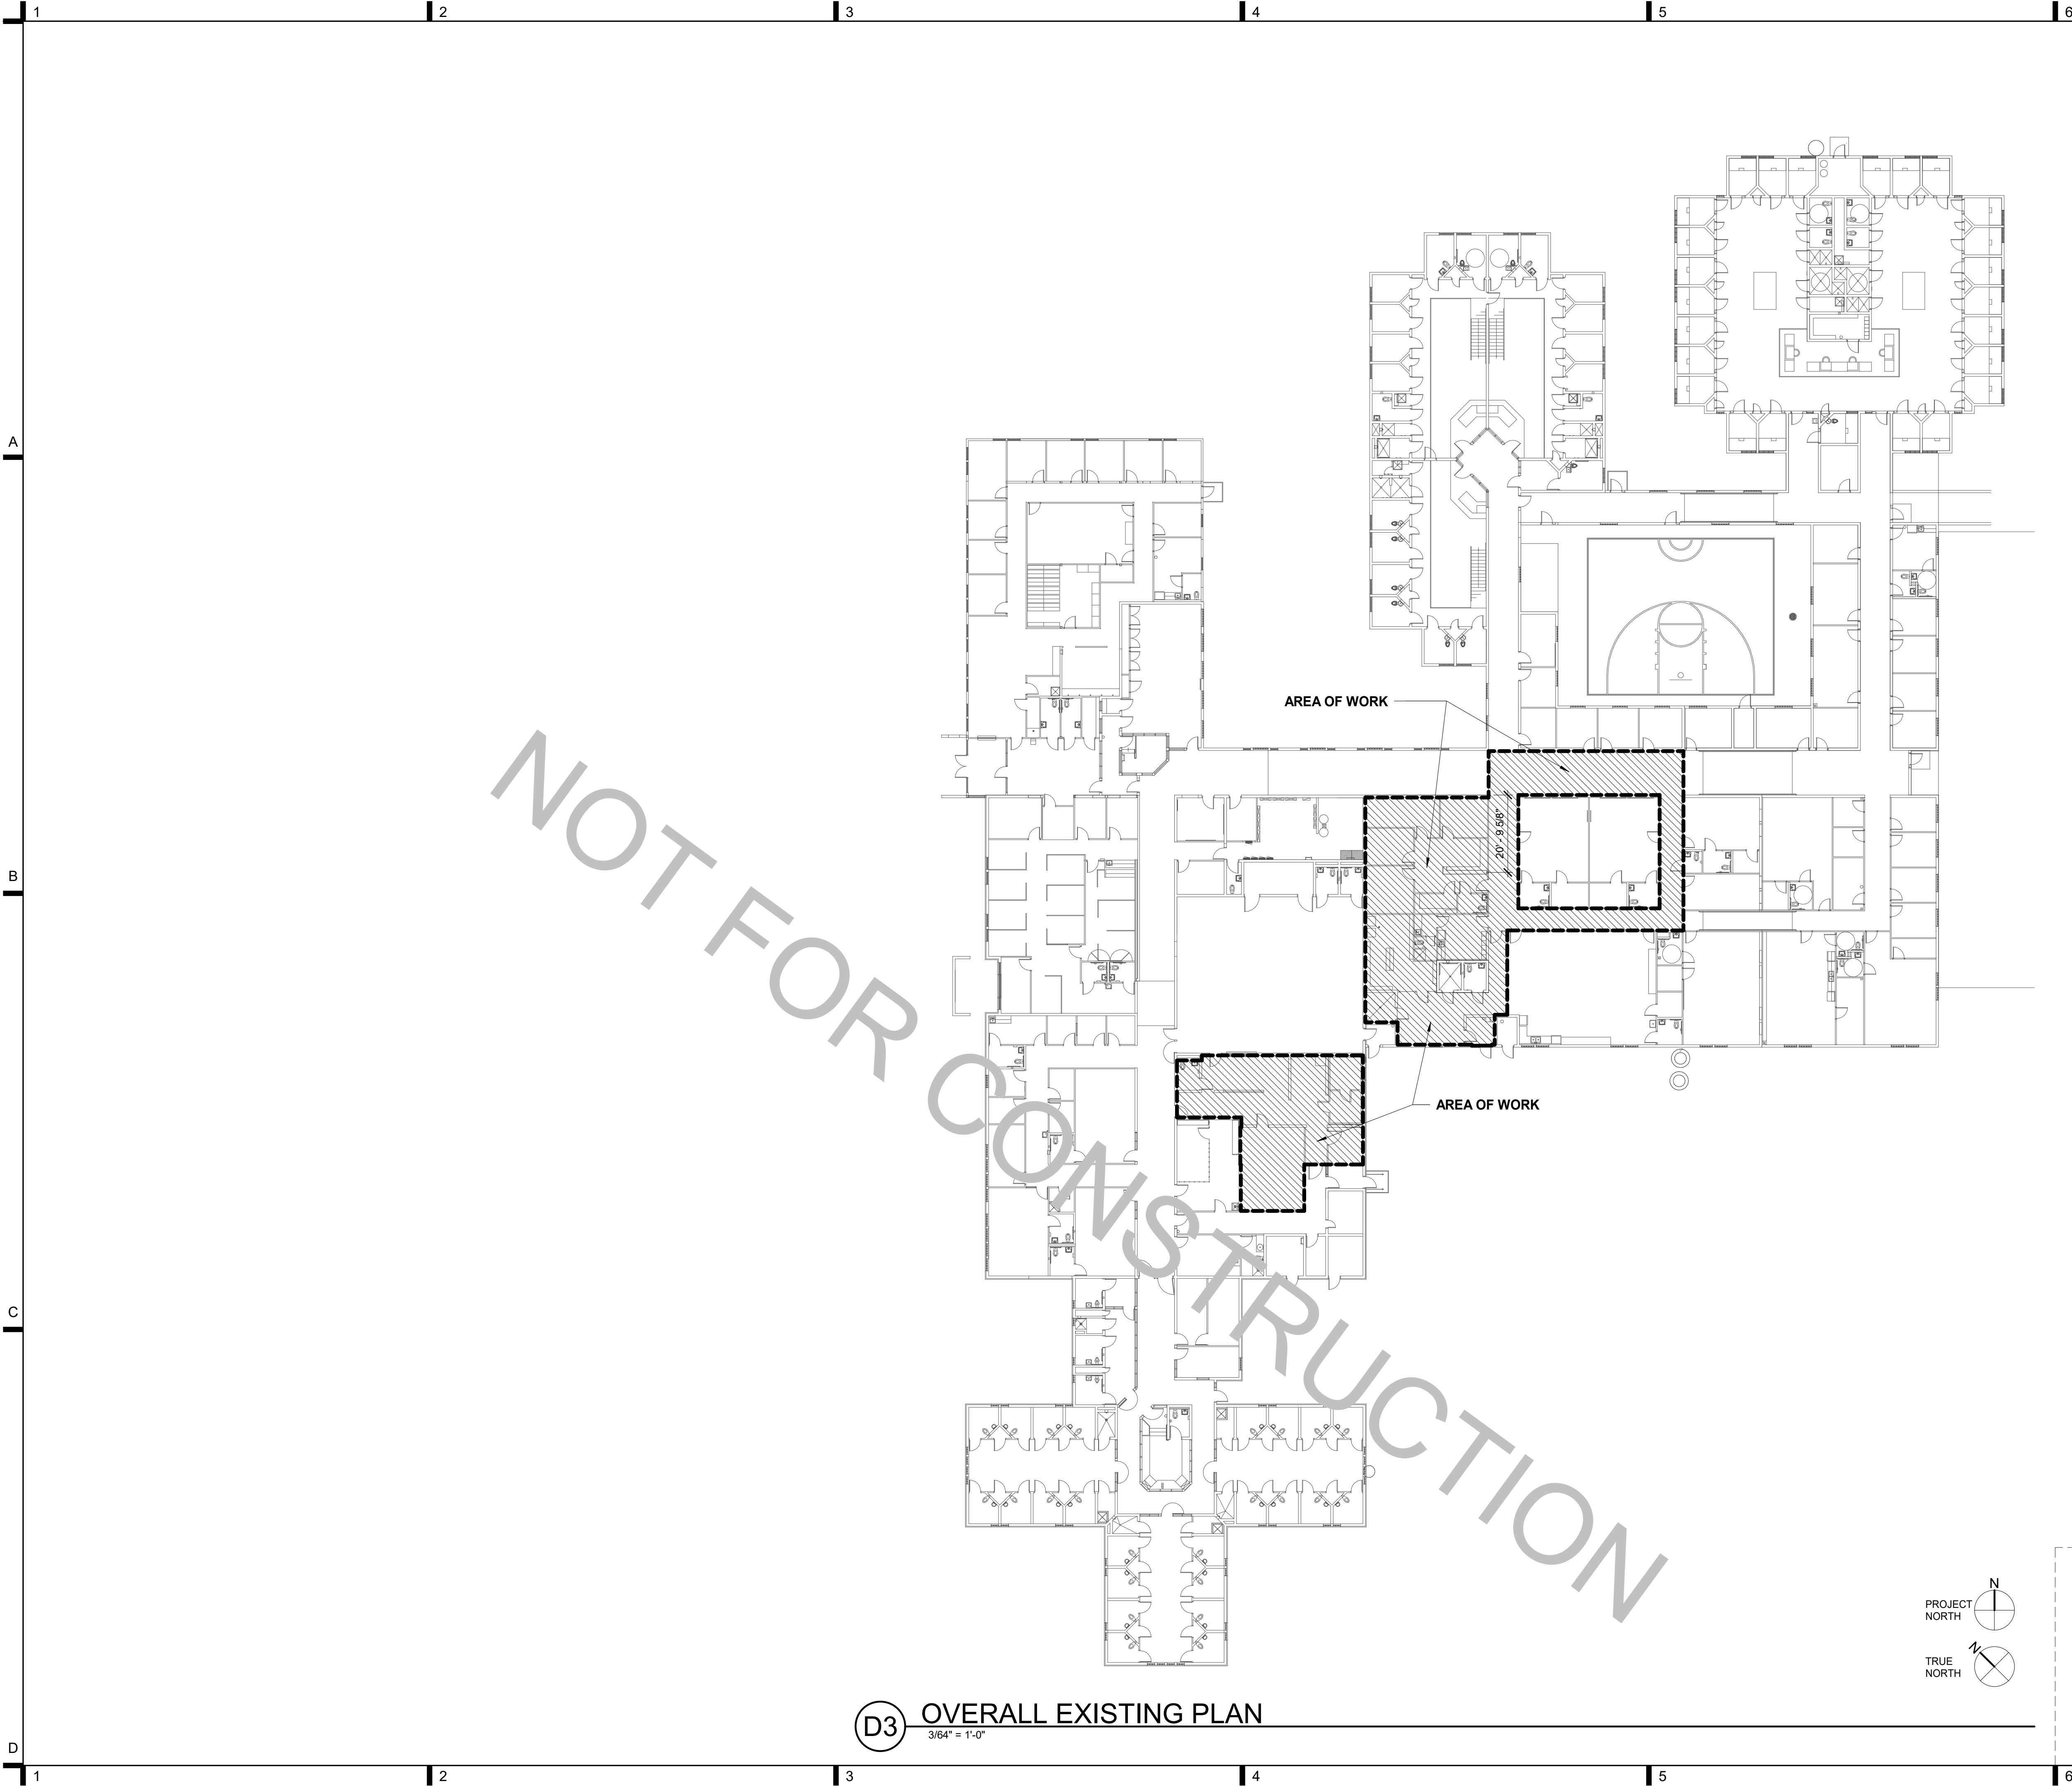1. PRIOR TO BEGINNING ANY DEMOLITION, A SURVEY OF THE PROPOSED DEMOLITION AREA SHALL BE MADE BY THE CONTRACTOR TO DETERMINE THE CONNECTIONS, FRAMING METHODS, AND CONDITIONS OF THE AREA TO BE DEMOLISHED.
2. ALL MATERIALS AND WORKMANSHIP SHALL CONFORM TO ALL APPLICABLE STATE AND LOCAL CODES, LAWS, AND REGULATIONS.
3. TAKE CAUTION TO PRESERVE AND PROTECT FINISHES, CASEWORK AND EQUIPMENT WHICH ARE TO REMAIN.
4. ALL DEMOLISHED MATERIALS SHALL BE PROPERLY DISPOSED IN ACCORDANCE WITH ALL CITY AND STATE REGULATIONS. ALL ITEMS THE OWNER DESIRES TO SALVAGE IN THE AREAS OF DEMOLITION SHALL BE IDENTIFIED PRIOR TO DEMOLITION. CONTRACTOR SHALL REMOVE AND DELIVER TO OWNER THOSE ITEMS IDENTIFIED.
5. EQUIPMENT MAY NEED TO BE REMOVED TO ACCOMMODATE NEW FINISHES AND REPLACED AFTER INSTALL. COORDINATE WITH NEW CONSTRUCTION SCOPE OF WORK.
6. PRIOR TO PAINTING OF WALLS, FILL ALL HOLES AND BLEMISHES SO THERE ARE NO NOTICEABLE SEAMS OR BREAKS IN FINISH MATERIAL.

KEYNOTES

1. REMOVE EXISTING HOLLOW METAL DOOR, FRAME AND ALL ASSOCIATED ITEMS. RE: NEW CONSTRUCTION SCOPE OF WORK.
2. REMOVE EXISTING WALL SYSTEM AND ALL ASSOCIATED ITEMS TO ACCOMMODATE NEW DOOR SYSTEM. RE: NEW CONSTRUCTION SCOPE OF WORK.
3. REMOVE EXISTING CMU WALL AND ALL ASSOCIATED ITEMS. RE: NEW CONSTRUCTION SCOPE OF WORK.
4. REMOVE EXISTING CHAIN LINK FENCING, MAIN GATE AND ALL ASSOCIATED ITEMS.
5. REMOVE EXISTING WALL HUNG SHELVING AND ALL ASSOCIATED ITEMS. RE: NEW CONSTRUCTION SCOPE OF WORK.
6. EXISTING WASHER AND DRYER TO BE REMOVED BY OWNER. MECHANICAL AND ELECTRICAL DRAWING AND NEW CONSTRUCTION SCOPE OF WORK.
7. REMOVE EXISTING SLAB ON GRADE TO ACCOMMODATE NEW THICKENED EQUIPMENT SLAB AND TROUGH DRAIN. RE: MECHANICAL DRAWINGS AND NEW CONSTRUCTION SCOPE OF WORK.
8. REMOVE EXISTING COUNTER TOP, SINK, FAUCET AND ALL ASSOCIATED ITEMS. RE: MECHANICAL DRAWINGS AND NEW CONSTRUCTION SCOPE OF WORK. RETAIN PLUMBING FOR NEW SINK.
9. REMOVE EXISTING PLASTIC LAMINATE VAHNSCOT FROM WALLS TO RECEIVE NEW FINISH MATERIAL. RE: NEW CONSTRUCTION SCOPE OF WORK.
10. REMOVE EXISTING FRAMED WALL AND ALL ASSOCIATED ITEMS. RE: NEW CONSTRUCTION SCOPE OF WORK.
11. REMOVE EXISTING WALK-IN FREEZER, REFRIGERATOR AND ALL ASSOCIATED ITEMS. RE: MECHANICAL, ELECTRICAL AND NEW CONSTRUCTION SCOPE OF WORK.
12. REMOVE EXISTING HANDWASH SINK AND ALL ASSOCIATED ITEMS. RE: MECHANICAL DRAWING AND NEW CONSTRUCTION SCOPE OF WORK.
13. REMOVE EXISTING WATER SOFTENER AND ALL ASSOCIATED ITEMS. RE: MECHANICAL DRAWINGS AND NEW CONSTRUCTION SCOPE OF WORK.
14. REMOVE EXISTING REFRIGERATOR.
15. REMOVE EXISTING KITCHEN EQUIPMENT TABLES.
16. REMOVE EXISTING STOVE, RANGE AND ALL ASSOCIATED ITEMS. RE: MECHANICAL DRAWINGS AND NEW CONSTRUCTION SCOPE OF WORK.
17. REMOVE EXISTING LOCKER SYSTEM AND ALL ASSOCIATED ITEMS.
18. REMOVE EXISTING JANITOR SINK AND ALL ASSOCIATED ITEMS. RE: MECHANICAL DRAWINGS AND NEW CONSTRUCTION SCOPE OF WORK.
19. REMOVE EXISTING SLAB ON GRADE FOR NEW SEWER LINE EXTENSION. RE: MECHANICAL DRAWINGS AND NEW CONSTRUCTION SCOPE OF WORK.
20. RETAIN AND PROTECT EXISTING WALL MURAL ON THIS WALL.
21. REMOVE EXISTING CMU WALL ABOVE OPENING AND ALL ASSOCIATED ITEMS. RE: NEW CONSTRUCTION SCOPE OF WORK.
22. REMOVE EXISTING FLOORING, WALL BASE AND FRP ON WALLS WHERE OCCURS TO ACCOMMODATE NEW FINISHES. RE: NEW CONSTRUCTION SCOPE OF WORK.
23. REMOVE EXISTING DOOR FRAME AND ALL ASSOCIATED ITEMS TO ACCOMMODATE NEW DOOR AND FRAME. RE: NEW CONSTRUCTION SCOPE OF WORK.
24. DASHED LINE INDICATES EXTENTS OF CHAIR RAIL REMOVAL FROM THIS WALL.
25. REMOVE EXISTING DOUBLE TIER LOCKERS AND RETAIN FOR REINSTALLATION.
26. EXISTING WATER HEATERS TO BE REPLACED. SEE MECHANICAL.
27. EXISTING ROOF ACCESS LADDER.
28. REMOVE EXISTING COUNTERTOP, BACKSPASH AND ALL ASSOCIATED ITEMS. PRESERVE AND PROTECT CASEWORK TO RECEIVE NEW COUNTERTOP. RE: NEW CONSTRUCTION SCOPE OF WORK.
29. REMOVE EXISTING COUNTERTOP, BASE CABINET AND OR SUPPORTS. RE: NEW CONSTRUCTION SCOPE OF WORK.
30. REMOVE ALL PAPER TOWEL DISPENSERS, TOILET PAPER DISPENSERS, TOILET SEAT COVER DISPENSERS, CLOTHES HOOKS, MIRRORS, SOAP DISPENSERS AND ANY OTHER WALL HUNG ITEMS TO ACCOMMODATE NEW PAINT AND FINISH. RE: NEW CONSTRUCTION SCOPE OF WORK. RETAIN ALL FOR REINSTALLATION AT THE SAME LOCATION. CONFIRM ALL LOCATIONS WITH OWNER PRIOR TO INSTALL.
31. REMOVE EXISTING SINK, FAUCET AND ALL ASSOCIATED ITEMS. RE: NEW CONSTRUCTION SCOPE OF WORK AND MECHANICAL DRAWINGS.
32. REMOVE EXISTING COUNTER TOP, BACKSPASH, SINK, FAUCET, CASEWORK AND ALL ASSOCIATED ITEMS. RE: MECHANICAL DRAWINGS AND NEW CONSTRUCTION SCOPE OF WORK. RETAIN PLUMBING FOR NEW WALL HUNG SINK.
33. REMOVE EXISTING COUNTERTOP, BACKSPASH, FINISH PANELS AND ALL ASSOCIATED ITEMS. RE: NEW CONSTRUCTION SCOPE OF WORK.
34. PROVIDE 12" CLEAR DIMENSION FROM DOOR TO FACE OF CABINET TO MEET ADA REQUIREMENTS. RELOCATE CASEWORK END PANEL AS REQUIRED TO ACCOMMODATE. RE: NEW CONSTRUCTION SCOPE OF WORK.

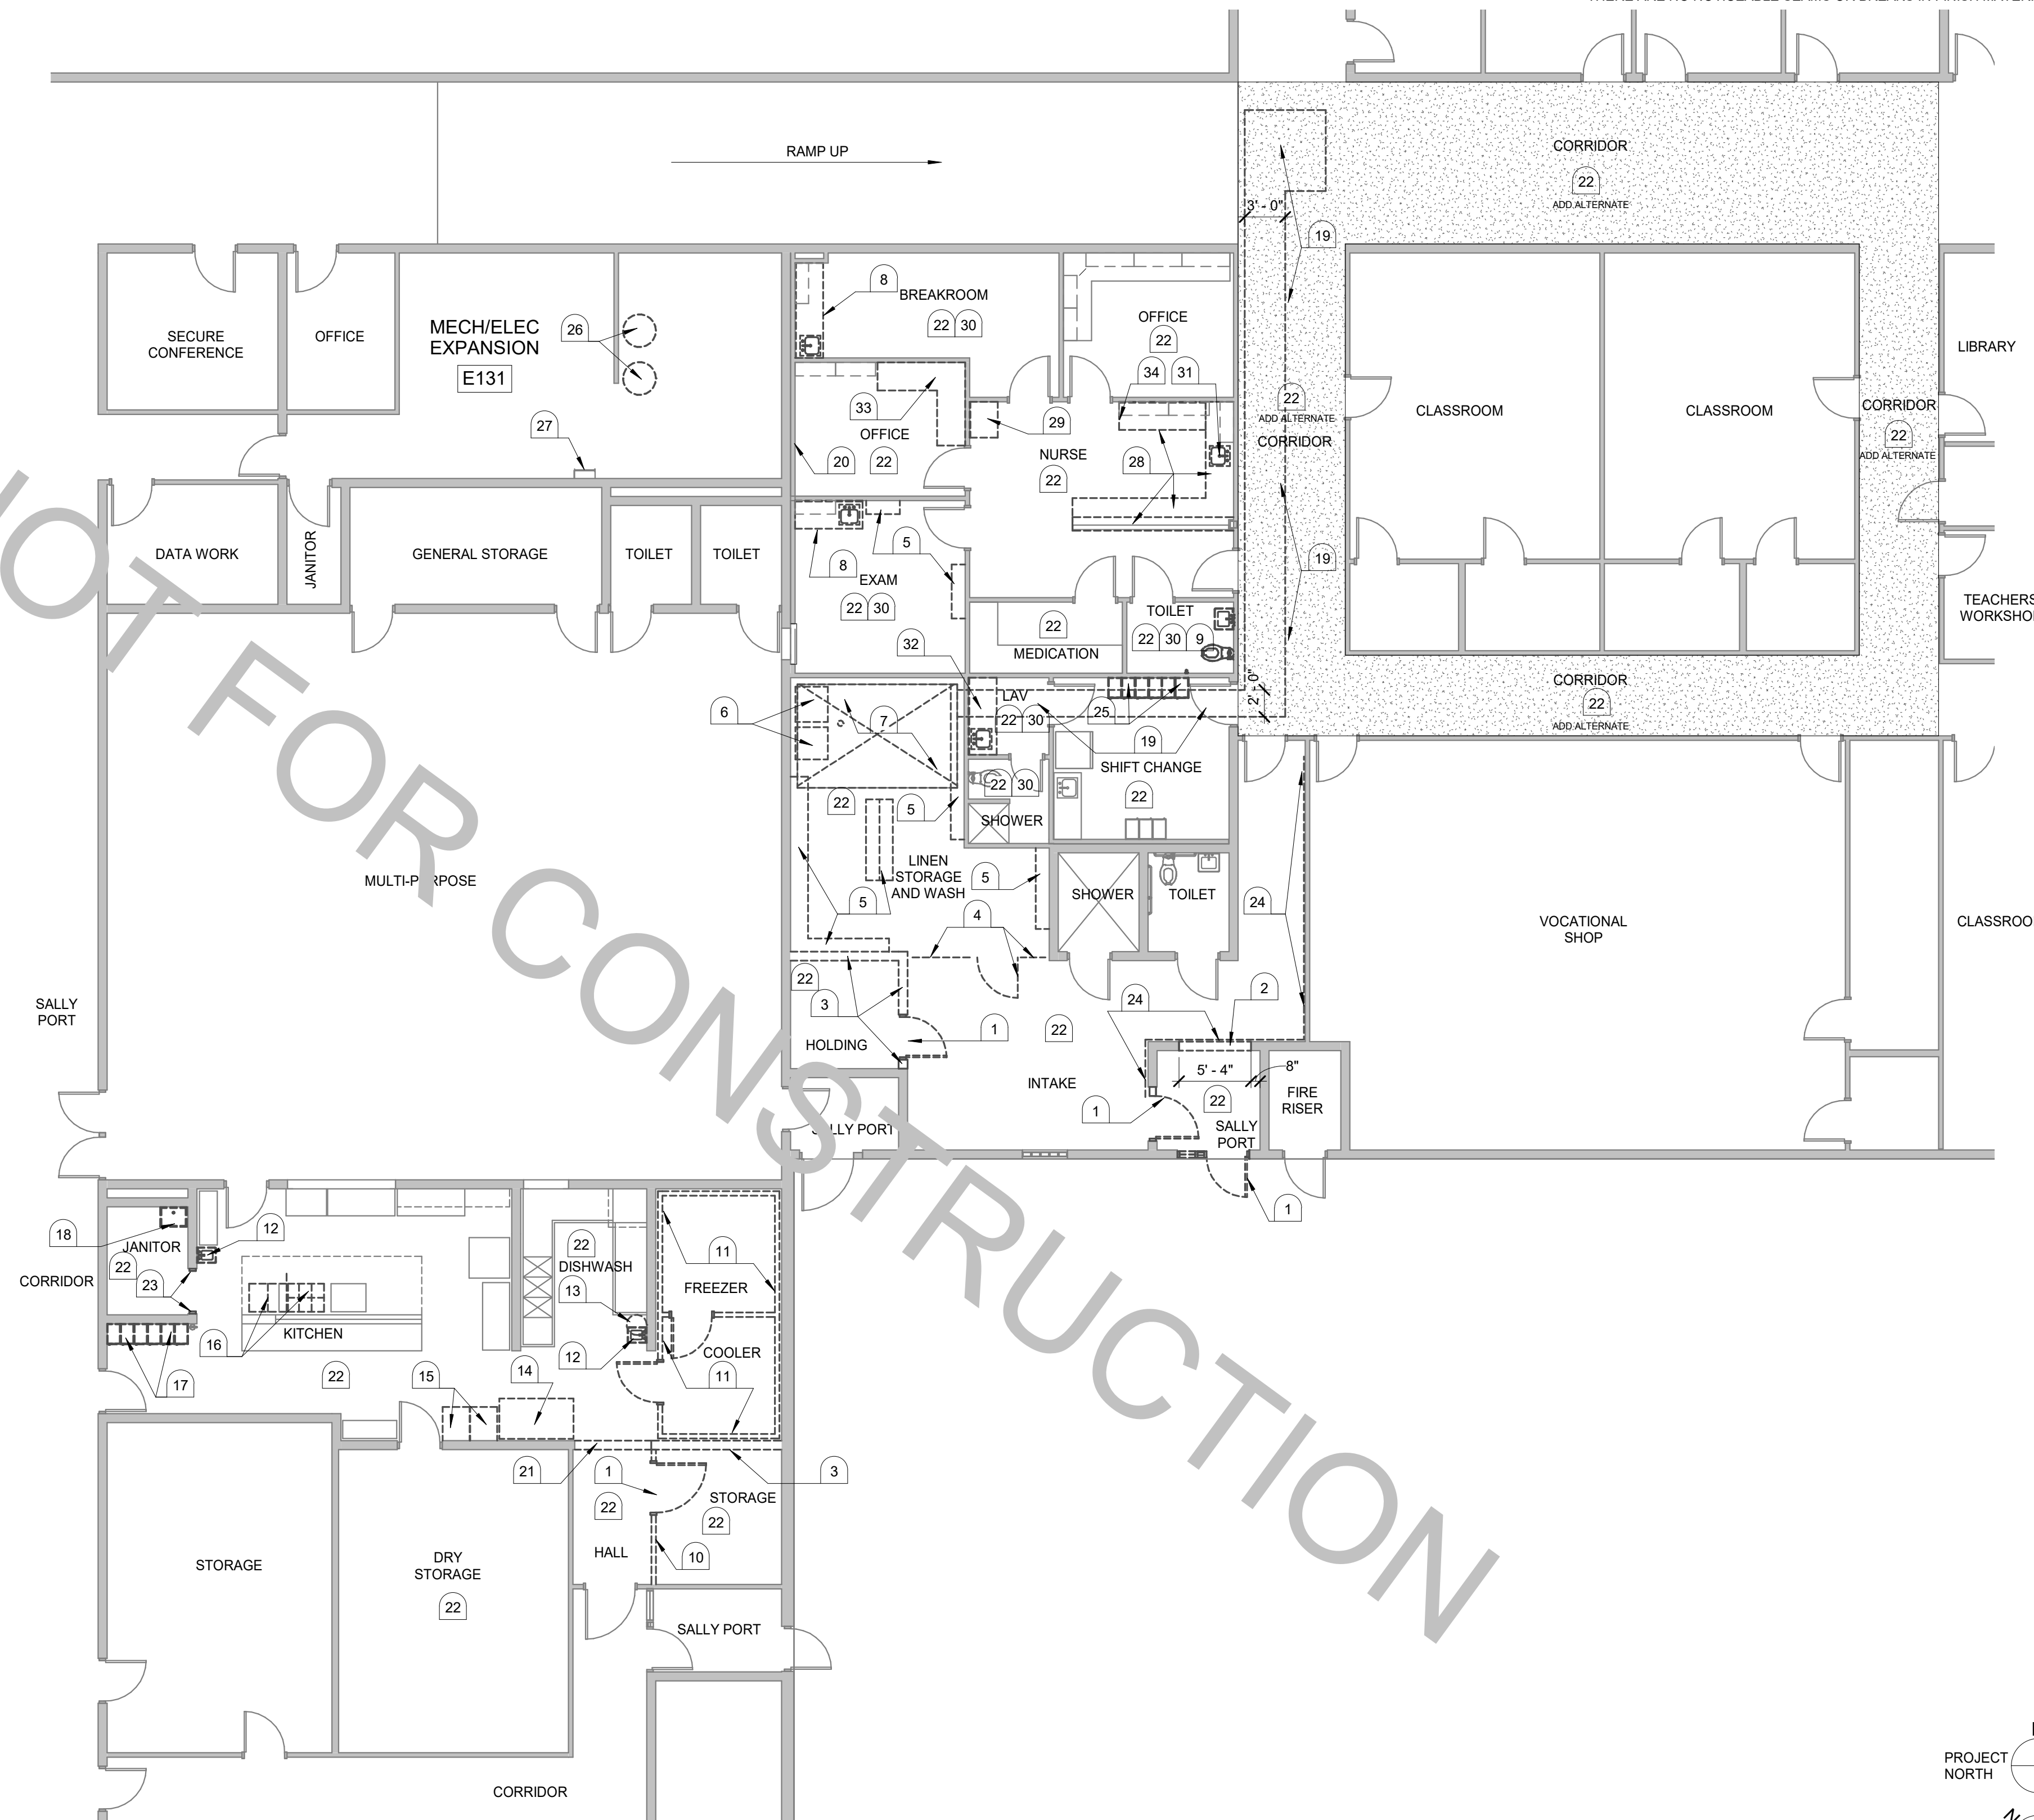

D2 DEMOLITION PLAN
1/8" = 1'-0"

APPROVAL AREA

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PW PROJECT
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CONSULTANT:

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DEMOLITION FLOOR PLAN

SHEET NO.

A2.0

D2 REFLECTED CEILING DEMOLITION PLAN
1/8" = 1'-0"

KEYNOTES

1. REMOVE EXISTING CEILING SYSTEM AND ALL ASSOCIATED ITEMS. RE-ELECTRICAL AND MECHANICAL DRAWINGS AND NEW CONSTRUCTION SCOPE OF WORK.
2. EXISTING CEILING TO REMAIN.
3. CUT DOWN EXISTING CEILING GRID AND TILES AT NEW FURRED WALL.

DEMOLITION GENERAL NOTES

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2. ALL MATERIALS AND WORKMANSHIP SHALL CONFORM TO ALL APPLICABLE STATE AND LOCAL CODES, LAWS, AND REGULATIONS.
3. TAKE CAUTION TO PRESERVE AND PROTECT FINISHES, CASEWORK AND EQUIPMENT WHICH ARE TO REMAIN.
4. ALL DEMOLISHED MATERIALS SHALL BE PROPERLY DISPOSED IN ACCORDANCE WITH ALL LAWS AND REGULATIONS. ALL ITEMS THE OWNER DESIRES TO SALVAGE IN THE AREAS OF DEMOLITION SHALL BE IDENTIFIED PRIOR TO DEMOLITION. CONTRACTOR SHALL REMOVE AND DELIVER TO OWNER THOSE ITEMS IDENTIFIED.
5. EQUIPMENT MAY NEED TO BE REMOVED TO ACCOMMODATE NEW FINISHES AND REPLACED AFTER INSTALL. COORDINATE WITH NEW CONSTRUCTION SCOPE OF WORK.

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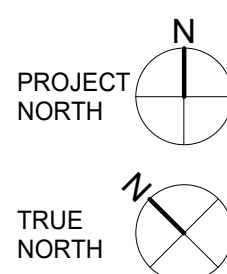
DEMOLITION
REFLECTED
CEILING PLAN

SHEET NO.

A2.1



D1 FINISH PLAN
1/8" = 1'-0"



ROOM FINISH SCHEDULE

ROOM NO.	ROOM NAME	FLOOR	BASE	WALLS				CEILING		REMARKS
				N	E	S	W	MAT.	FIN.	
100	SALLY PORT	EM	RB1	EP1	EP1	EP1	EP1	EX	P1	2, 3
101	INTAKE	RSF2	RB1	EP1	EP1	EP1	FRP2	ACP1	FF	1, 2
102	LAUNDRY	RSF2	RB2	FRP2	FRP2	FRP2, EP1	FRP2	ACP2	FF	1, 2, 5
103	HALL	RSF2	RB1	EP1	EP1	EP1	EP1	ACP1	FF	1, 2, 3, 6
104	DISH WASH	RSF2	RSF2	FRP1	FRP1	FRP1	FRP1	EX	EP1	2, 3, 4
105	KITCHEN	RSF2	RSF2	FRP1	FRP1	FRP1	FRP1	EX	EP1	2, 3, 4
106	JANITOR	RSF2	RSF2	EP1/FRP1	EP1/FRP1	EP1	EP1	EX	EP1	1, 2, 3, 4
107	HALL	RSF2	RSF2	--	--	FRP1	FRP1	EX	EP1	2, 3, 4
108	DRY STORAGE	RSF2	RSF2	EP1	EP1	EP1	EP1	ACP2	EP1	2, 3, 4
109	COOLER	RSF2	RSF2	--	--	--	--	--	--	12
110	FREEZER	RSF2	RSF2	--	--	--	--	--	--	12
111	DRYERS	NF	NF	NF	NF	NF	NF	OTS	NF	--
112	CORRIDOR	CPT1	RB1	--	--	--	--	--	--	8, 9, 11
113	SHIFT CHANGE	CPT1	RB1	P1	P1	P1	P1	--	--	7, 9
114	LAVATORY	RSF3	RB2	EP1	EP1	EP1	EP1	--	--	3, 5, 9
115	TOILET/ SHOWER	RSF3	RB2	EP1	EP1	EP1	EP1	--	--	3, 5, 9
116	NURSE	CPT2/RTF	RB1	P3	P3	P1	P1	--	--	7, 9, 13
117	TOILET	RSF1	RSF1	EP1/WP3	EP1/WP3	EP1/WP3	EP1/WP3	--	--	1, 3, 4, 9
118	MEDICATION	RSF1	RB1	P1	P1	P1	P1	--	--	9
119	EXAM	RTF	RB1	P3/WP3	P1	P1	P1	--	--	1, 7, 10
120	OFFICE	CPT2	RB1	P1	P1	P1	P1	--	--	9, 10
121	BREAKROOM	RTF	RB1	P4	P1	P1	P1	--	--	7, 9
122	OFFICE	CPT2	RB1	P1	P4	P1	P1	--	--	7, 9
123	CORRIDOR	CPT1	RB1	--	--	--	--	--	--	8, 9, 11
124	CORRIDOR	CPT1	RB1	--	--	--	--	--	--	8, 9, 11
125	CORRIDOR	CPT1	RB1	--	--	--	--	--	--	8, 9, 11

ROOM FINISH REMARKS

- MULTIPLE WALL FINISHES AT THIS LOCATION. REFER TO FINISH PLAN FOR EXTENT.
- EPOXY PAINT AT ALL CMU WALLS IN THIS LOCATION.
- EPOXY PAINT AT ALL GYPSUM SURFACES IN THIS LOCATION.
- PROVIDE 6" INTEGRAL SELF-COVE BASE AT THIS LOCATION. REFER TO DETAILS B5 / A4.0 AND C5 / A4.0.
- PROVIDE BEAD OF SEALANT AT TOP AND BOTTOM EDGE OF RUBBER BASE IN THIS LOCATION. REFER TO DETAIL D5 / A4.0.
- DUAL WALL GUARD AT THIS LOCATION. REFER TO FINISH PLAN FOR EXTENT.
- ACCENT PAINT AT THIS LOCATION.
- NEW FLOORING AND BASE AT THIS LOCATION. WORK IN THIS ROOM TO BE PART OF ADD ALTERNATE # xxxxxxxxxxxxxxxx. REFER TO SPEC. SECTION 012300.
- EXISTING CEILING TO REMAIN.
- EXISTING MURAL AT WEST WALL OF THIS ROOM TO REMAIN.
- EXISTING WALL FINISHES TO REMAIN AT THIS LOCATION. TAKE PRECAUTION TO PROTECT FROM DAMAGE.
- PREFABRICATED FACTORY FINISH WALL AND CEILING AT FREEZER / COOLER UNITS.
- MULTIPLE FLOOR FINISHES AT THIS LOCATION. REFER TO FINISH PLAN FOR EXTENT.

KEYNOTES

- DUAL WALL GUARD (WP1) AND (WP2) AT THIS LOCATION. SEE DETAIL D4 / A4.0. TERMINATE 3" FROM CORNERS, DOOR AND WINDOW FRAMES. DO NOT MITER.
- FIBERGLASS REINFORCED WALL PANEL (FRP2) AT THIS LOCATION, FULL HEIGHT.
- FIBERGLASS REINFORCED WALL PANEL (FRP1) WAINSCOT AT THIS LOCATION. INSTALL TO 54" A.F.F., EPOXY PAINT ABOVE.
- RIGID SHEET WALL PROTECTION (WP3) AT THIS LOCATION. SEE ELEVATION FOR LAYOUT AND EXTENT.
- ALIGN FLOOR FINISH TRANSITION WITH FACE OF WALL, MILLWORK OR DOOR FRAME AS INDICATED.

MATERIAL LEGEND

SYMBOL	DESCRIPTION
ACP	SUSPENDED ACOUSTICAL CEILING PANEL (095113)
CPT	CARPET TILE (096813)
EM	ENTRY MAT (096813)
EP	EPOXY PAINT (099123)
EX	EXISTING TO REMAIN
FRP	FIBERGLASS REINFORCED WALL PANEL (066400)
GYP	GYPSUM BOARD (092900)
L	LOCKERS (105113)
NF	NO FINISH
OTS	OPEN TO STRUCTURE
P	PAINT (099123)
RB	RUBBER BASE (096513)
RSF	RESILIENT SHEET FLOORING (096516)
RTF	RESILIENT TILE FLOORING (096519)
WP	WALL PROTECTION (102600)

FINISH LEGEND

SYMBOL	DESCRIPTION
	NOT IN SCOPE
CPT1	CARPET TILE (096813)
CPT2	CARPET TILE (096813)
RTF	RESILIENT TILE FLOORING (096519)

GENERAL FINISH NOTES

- MATERIAL HATCHES ARE SHOWN IN AREAS WHERE MULTIPLE FLOOR FINISHES OCCUR. REFER TO ROOM FINISH SCHEDULE FOR FINISH DESIGNATION.
- NUMBERS AFTER SYMBOLS REPRESENT DIFFERENT STYLES AND COLORS AS DEFINED IN SPECIFICATIONS.
- TERMINATE DISSIMILAR COLORS AND FINISHES WITH CLEAN, CRISP, STRAIGHT LINE.
- PAINT ALL SURFACES OF H.M. FRAMES, H.M. DOORS, LOUVERS AND GRILLS U.N.O. COLORS AS SELECTED BY ARCHITECT.
- PROVIDE SEALANT AT ALL GYP. BOARD TO DISSIMILAR MATERIALS.
- ALL GYPSUM BOARD ON RESTROOM AND JANITOR ROOM WALLS SHALL BE MOISTURE RESISTANT.
- ALL EXPOSED CMU SURFACES TO BE PAINTED (099113).
- SEE DETAIL A5 / A4.0 FOR TYPICAL FLOOR TRANSITIONS.
- THRESHOLDS TO OCCUR AT CENTERLINE OF DOOR UNLESS NOTED OTHERWISE.
- SEE REFLECTED CEILING PLAN SHEET A2.4 FOR SOFFIT AND FURR-DOWNS AND OTHER CEILING FEATURES.
- SEE DETAIL A1 / A8.0 FOR TYPICAL WALL MOUNTED ACCESSORIES.
- SEE DETAIL A3 / A8.0 FOR TYPICAL ADA SIGNAGE MOUNTING. SEE SPECIFICATION SECTION 101423.

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CONSULTANT:

MRK	DATE	DESCRIPTION
1	Date 1	Revision 1


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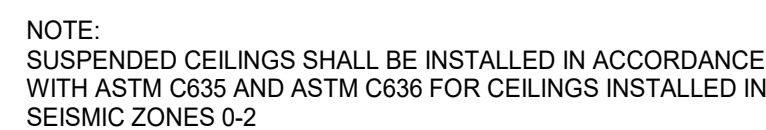
FINISH PLAN &
ROOM FINISH
SCHEDULE

SHEET NO.

A2.3



A2 **GYP. BRD. CEILING**
3" = 1'-0" CD004-ABC

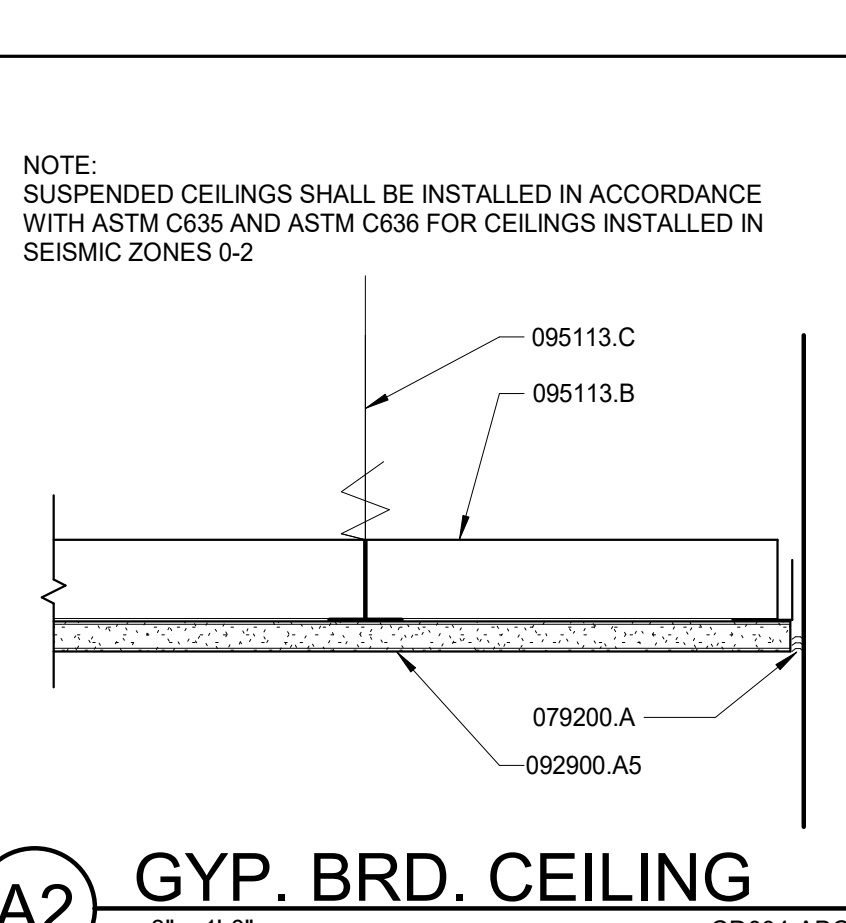

8 1/32"
MAX.

HANGER WIRE,
MAX 1 IN 6 FROM
VERT.


7/8"
MIN.

SPACER BAR

NOTE:
SUSPENDED CEILINGS SHALL BE INSTALLED IN ACCORDANCE WITH
ASTM C635 AND ASTM C638 FOR CEILINGS INSTALLED IN SEISMIC
ZONES 0-2

Diagram illustrating a grid structure with labels B1 A2.4 and C1 A2.4. The grid is composed of intersecting lines forming a mesh. Two specific points or regions are highlighted and labeled: B1 A2.4 and C1 A2.4.

D2 REFLECTED CEILING PLAN
1/8" = 1'-0"

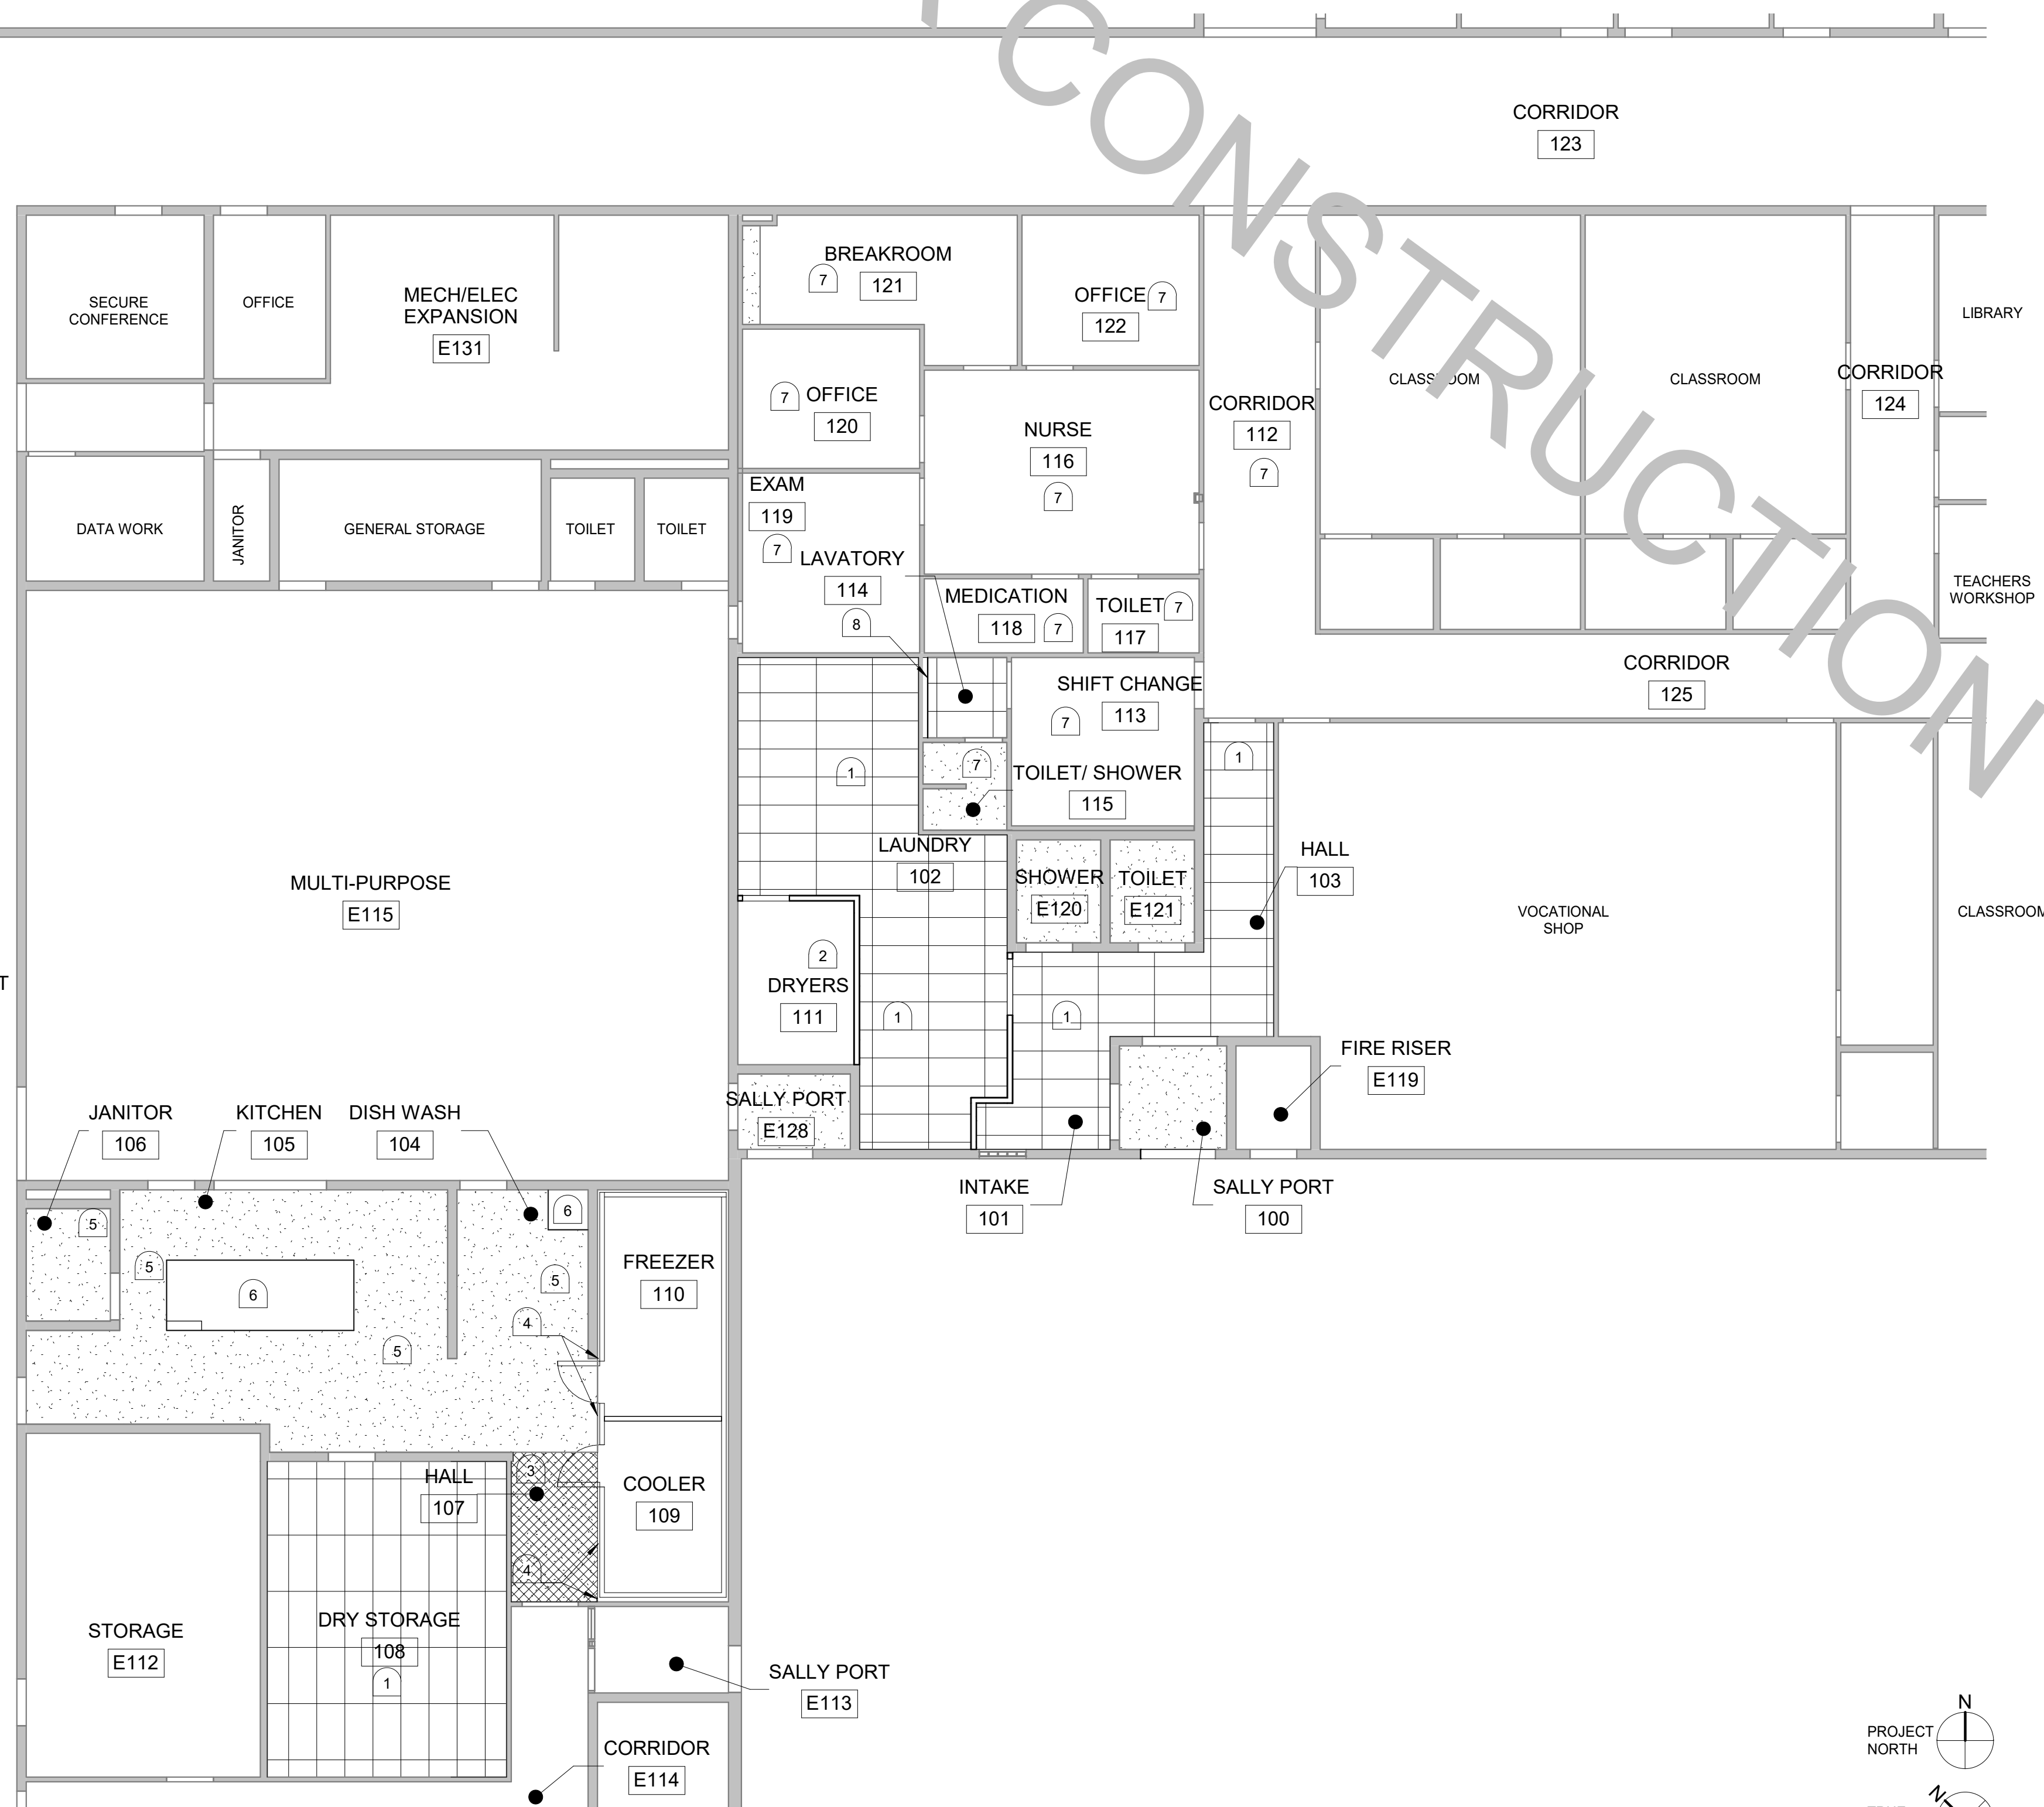

D2 REFLECTED CEILING PLAN
1/8" = 1'-0"

079200.A	JOINT SEALANT.
092900.A5	5/8" TYPE X GYPSUM BOARD.
095113.B	METAL SUSPENSION SYSTEM
095113.C	WIRE HANGER.

1. NEW CEILING AND GRID. REFER TO DETAIL **A6/A2.4**.
2. NO CEILING THIS SPACE, OPEN TO STRUCTURE.
3. NEW SUSPENDED GYPSUM BOARD CEILING, SEE DETAIL **A2/A2.4**.
CLOSURE AT JAMBS AND HEAD OF OPENING BY FREEZER/COOLER
INSTALLER.
5. EXISTING GYPSUM BOARD CEILING TO REMAIN AND BE REPAINTED.
6. EXISTING HOOD TO REMAIN.
7. EXISTING CEILING TO REMAIN IN THIS ROOM.
8. CUT DOWN EXISTING CEILING GRID AND TILES AT NEW FURRED
WALL

1. SEE ROOM FINISH SCHEDULE FOR ADDITIONAL FINISH INFORMATION.
2. PAINT ALL DUCT WORK, CONDUIT, AND PIPING EXPOSED TO VIEW.
3. SEE **A1/A2.4** FOR TYPICAL CEILING LAYOUT.

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LAUNDRY,
KITCHEN & CLINIC
REMODEL - JCCN**

**IDJC - JCC NAMPA
DPW PROJECT
#21535**

CONSULTANT:

MRK	DATE	DESCRIPTION


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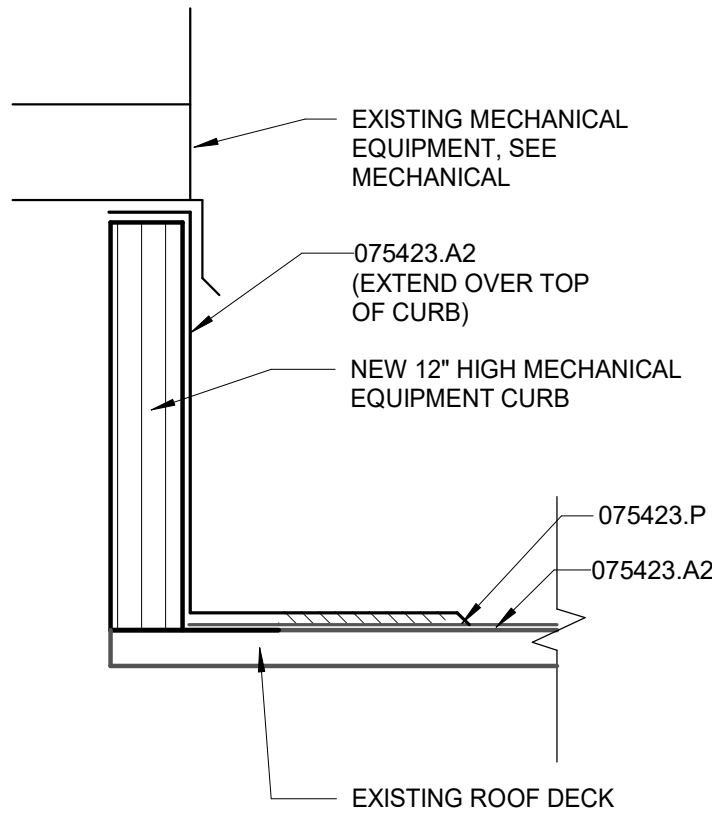
REFLECTED
CEILING PLAN

SHEET NO. _____



A2.4



A2 ROOF PENETRATION
3" = 1'-0"

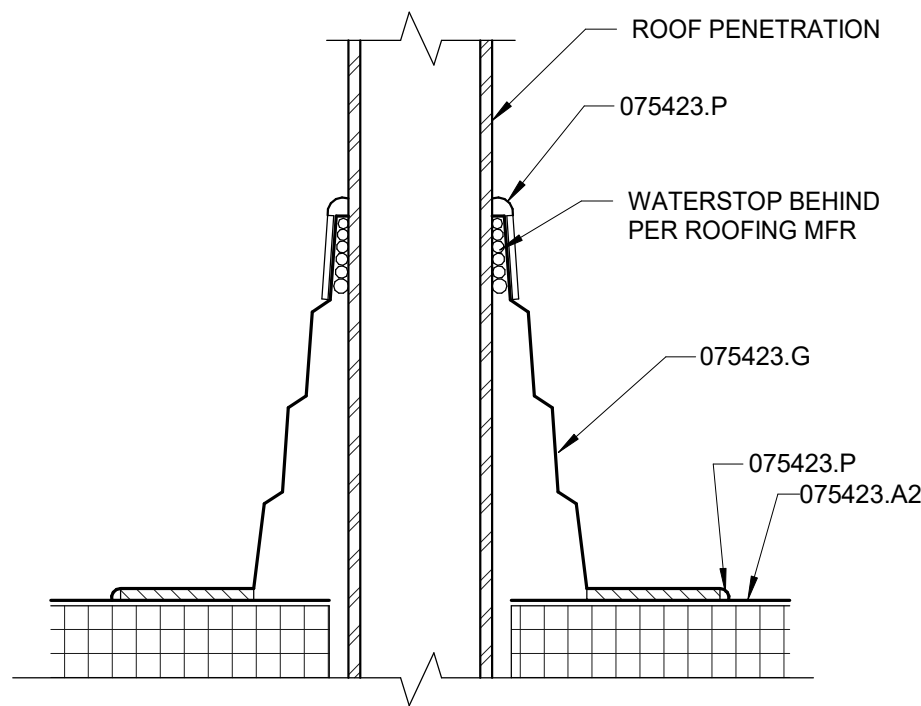

B2 ROOF CURB DETAIL
3" = 1'-0"

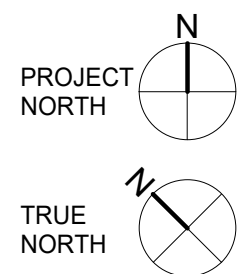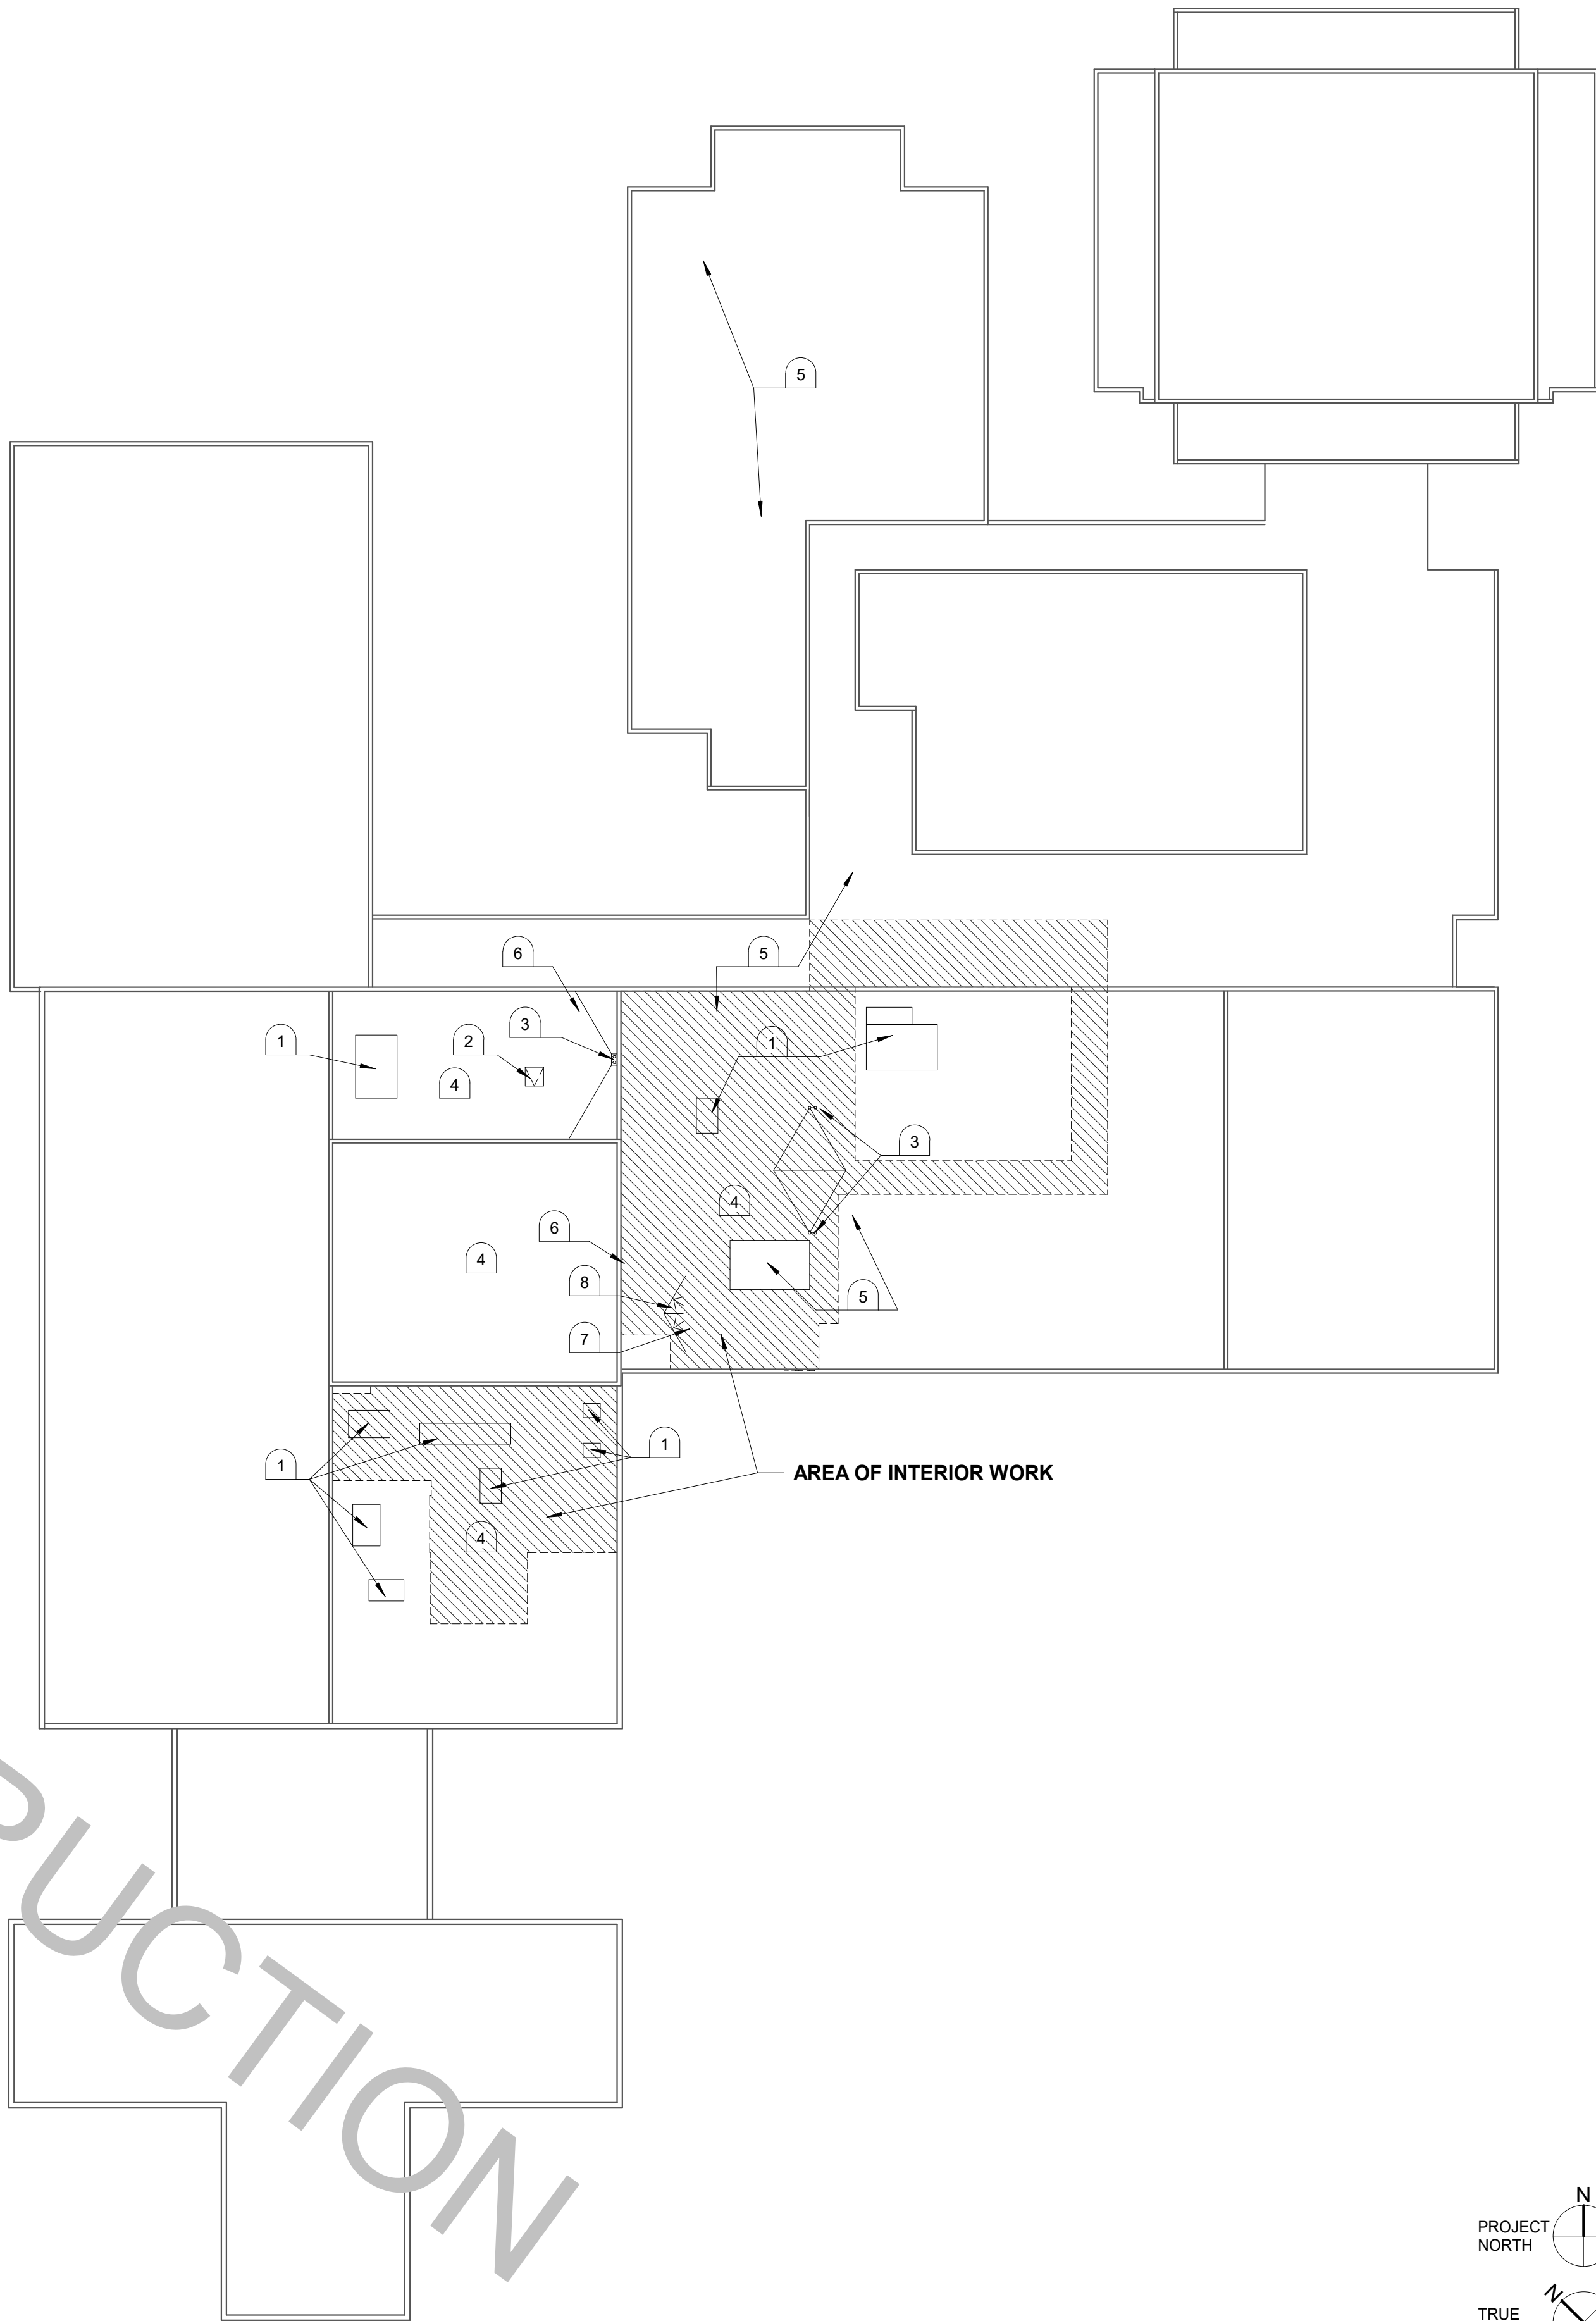

D3 ROOF PLAN
3/64" = 1'-0"

CONDOC

075423.A2
075423.G
075423.P

MECHANICALLY FASTENED TPO ROOFING.
PREFORMED CONE AND VENT FLASHING.
SEALANT

KEYNOTES

1. EXISTING ROOFTOP EQUIPMENT.
2. EXISTING ROOF ACCESS HATCH.
3. EXISTING ROOF DRAIN.
4. EXISTING ROOF TO REMAIN, PROTECT DURING CONSTRUCTION.
5. NEW GAS PIPING, SEE MECAHNICAL.
6. NEW ROOFTOP PIPING PENETRATION, SEE MECAHNICAL. SEE **A1/A2.5**.
7. NEW RTU, SEE MECAHNICAL. SEE **B1/A2.5**.
8. CONSTRUCT NEW ROOF CRICKET AT UPHILL SIDE OF NEW RTU.

GENERAL NOTES

1. EXISTING ROOFING MEMBRANE IS TPO.
1. PROVIDE CRICKETS AS REQUIRED FOR POSITIVE DRAINAGE (SLOPE 3/8" P.L.F. WITH FALL LINE OF SLOPE OR 1/4" MIN.). ARROW INDICATES DIRECTION OF ROOF OR CRICKET SLOPE.
2. SEE DETAIL **B1/A2.5** FOR TYPICAL ROOFING MEMBRANE WALL BASE FLASHING DETAIL.
3. PROVIDE WATER TIGHT SEAL AROUND ALL ROOFTOP EQUIPMENT AND PENETRATIONS, INCLUDING THOSE NOT SHOWN HERE. REFER TO MECHANICAL DRAWINGS FOR EQUIPMENT NOT SHOWN HERE.

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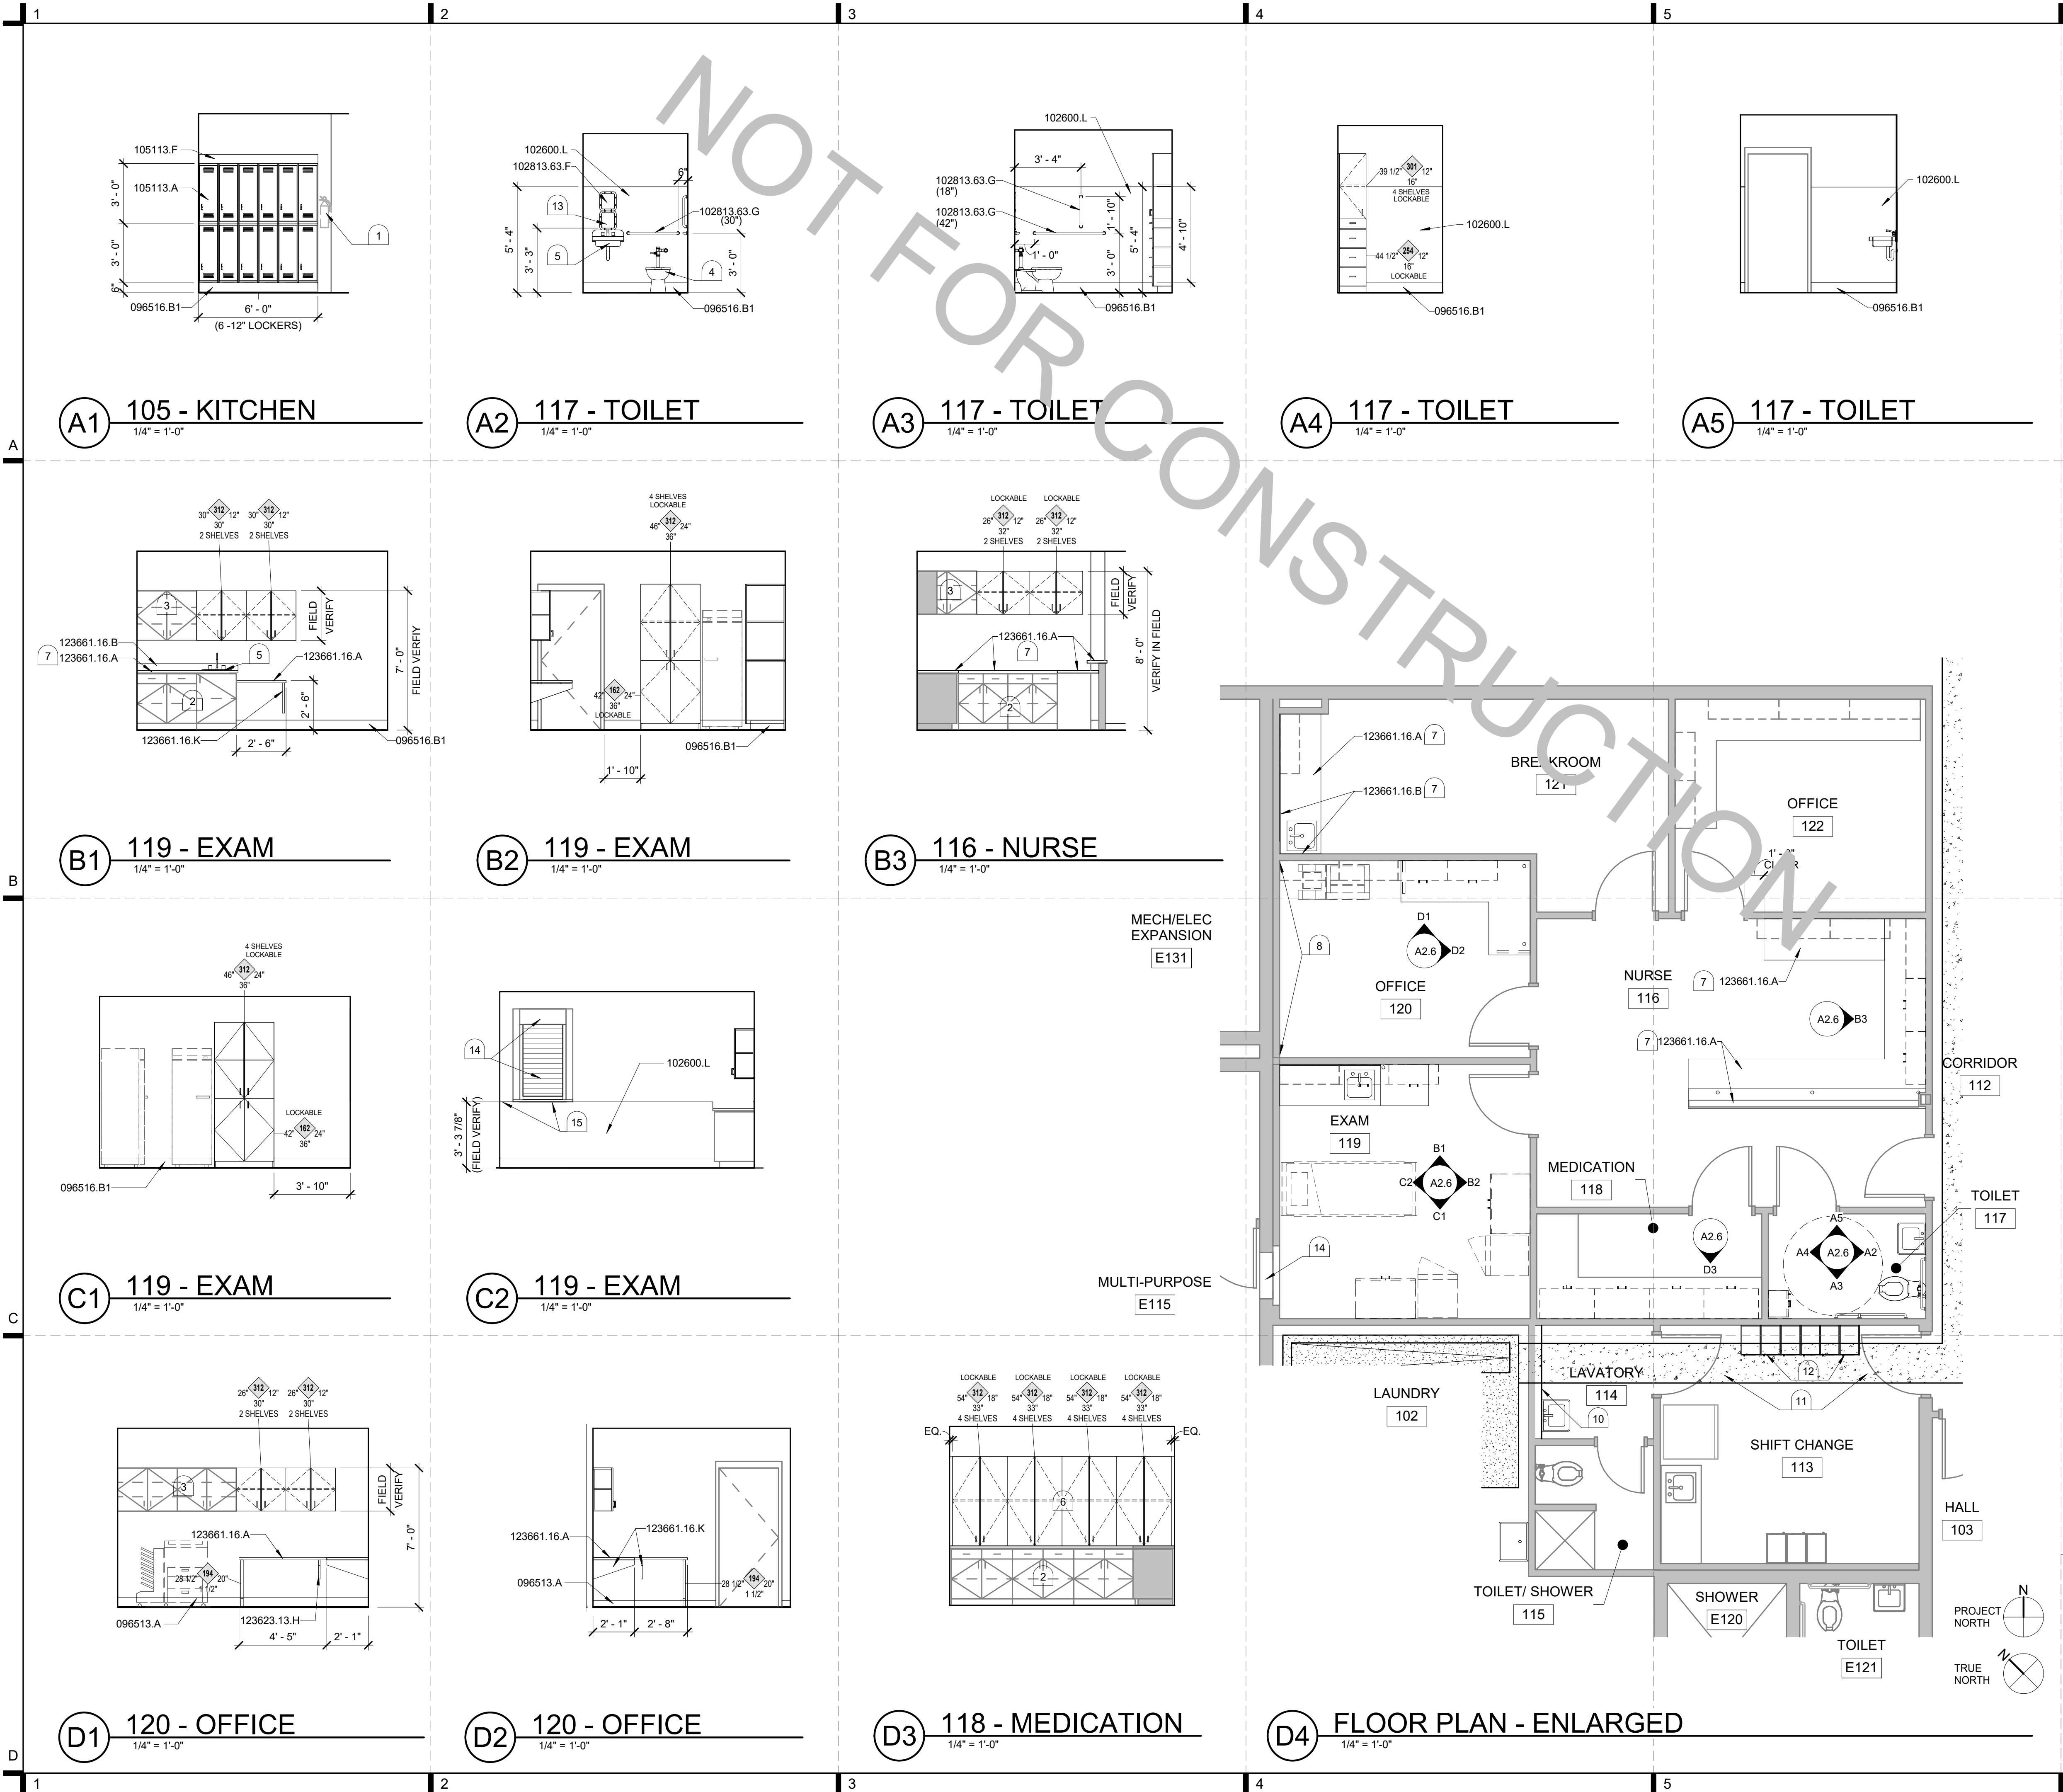
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ROOF PLAN

SHEET NO.

A2.5



CONDOC

096513.A	RESILIENT BASE.
096516.B1	6" INTEGRAL FLASH-COVE-BASE.
102600.L	IMPACT-RESISTANT WALL COVERING.
102813.63.F	DETENTION MIRROR
102813.63.G	DETENTION GRAB BARS
105113.A	CORRIDOR LOCKER.
105113.F	SLOPING TOP.
123623.13.H	KNEE BRACE.
123661.16.A	SOLID SURFACE COUNTERTOP
123661.16.B	SOLID SURFACE BACKSPLASH
123661.16.K	KNEE BRACE

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KEYNOTES

- PRESERVE AND PROTECT EXISTING K TYPE FIRE EXTINGUISHER TO REMAIN AT THIS LOCATION.
- PRESERVE AND PROTECT EXISTING BASE CABINETS TO REMAIN.
- PRESERVE AND PROTECT EXISTING UPPER CABINETS TO REMAIN.
- NEW TOILET, RE: MECHANICAL DRAWINGS.
- NEW SINK, RE: MECHANICAL DRAWINGS.
- INSTALL NEW BASE CABINET ONTOP OF EXISTING TO REMAIN COUNTERTOP.
- NEW COUNTERTOP OVER EXISTING BASE CABINET TO MATCH EXISTING LENGTH AND DEPTH. RE: FINISH DRAWINGS FOR FINISH MATERIAL.
- RETAIN AND PROTECT EXISTING MURAL ON THIS WALL.
- NEW CABINET, SEE ELEVATIONS.
- INSTALL NEW 3 5/8" STEEL STUD WALL.
- PATCH BACK SLAB ON GRADE AND FLOORING IN THIS AREA.
- REINSTALLATION EXISTING DOUBLE TIER LOCKERS AT THE SAME LOCATION.
- EXISTING DETENTION MIRROR TO BE REINSTALLED AFTER PAINTING OF WALLS.
- EXISTING COILING DOOR WITH SILL.
- ALIGN NEW WALL PROTECTION WITH BOTTOM OF COILING WINDOW SILL.

GENERAL MILLWORK NOTES

- REFERENCE **NAAWS (NORTH AMERICAN ARCHITECTURAL WOODWORK STANDARDS, CDS VERSION 3.1, 2017 OR LATER FOR CABINET TYPES AND DESIGNATIONS. NAAWS-CDS.COM**
NAAWS TYPE: (101)
TYPES DENOTED (S): SEE BELOW FOR ADDITIONAL INFORMATION.
NOTE: HEIGHT, WIDTH, DEPTH, RESPECTIVELY. ADDITIONAL INFORMATION.
- REFER TO SPECIFICATION SECTION 064116.
- PROVIDE PLASTIC LAMINATE ON EACH EXPOSED SURFACE OF CABINETS, INCLUDING OPEN CABINETS. U.O.N.
- VERIFY FIELD DIMENSIONS PRIOR TO FABRICATION.
- CONTINUE BACK SPLASH ALONG BACK OF COUNTERTOP AND SIDES ADJACENT TO WALLS U.O.N.
- PROVIDE STIFFENERS, BRACING, BACK-UP PLATES, AND ACCESSORIES FOR FRAMING TO SUPPORT CABINETS, ACCESSORIES.

APPROVAL AREA

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INTERIOR
ELEVATIONS &
ENLARGED PLAN

SHEET NO.

A2.6



WALL TYPES LEGEND

INTERIOR

WALL MATERIAL

3 - CONCRETE - SPEC. SECTION 033000

4 - MASONRY - SPEC. SECTION 042000

5 - LOAD-BEARING METAL STUD - SPEC. SECTION 054000

6 - WOOD STUD - SPEC. SECTION 061000

9 - NON-LOAD BEARING METAL STUD - SPEC. SECTION 092216

NOMINAL WALL WIDTH:

0 = 7/8" FURRING	5 = C-H SHAFT WALL STUD
1 = 1 5/8"	6 = 6" (5 1/2" WOOD)
2 = 2 1/2"	8 = 8" (7 1/4" WOOD)
3 = 3 5/8"	10 = 10"
4 = 4" (3 1/2" WOOD)	12 = 12"


WALL PROPERTIES
C = CEILING HEIGHT WALL
F# = FIRE RATED WALL
 # REPRESENTS RATING IN HOURS (ie; 93.F1, 93.F2)
P = PARTIAL HEIGHT WALL
S = SOUND WALL

NOTES:

1. REFER TO INDIVIDUAL WALL TYPES FOR ALL INFORMATION.
2. WALL DESIGNATIONS MAY INCLUDE MULTIPLE WALL PROPERTY CHARACTERS.
3. ALL INTERIOR PARTITIONS HAVE GYPSUM BOARD BOTH SIDES TO HEIGHT INDICATED UNLESS NOTED OTHERWISE.
4. ALL INTERIOR WALLS TO HAVE SOUND ATTENUATION BLANKETS.

INTERIOR WALL TYPES

9 SERIES

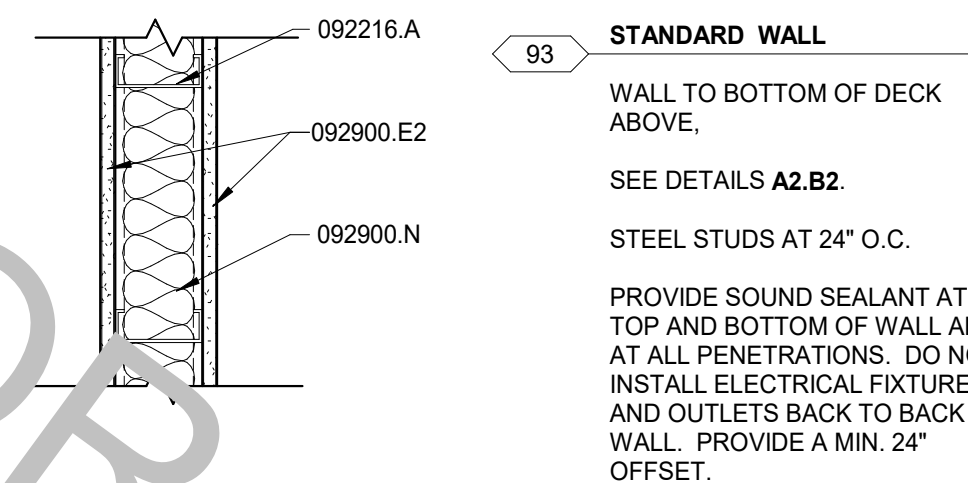


DOOR SCHEDULE

MARK	1. DOOR OPENING		SEE DOOR LEGEND								DETAILS - SEE THIS SHEET U.O.N.			REMARKS
	WIDTH	HEIGHT	2. DOOR TYPE	3. DOOR CONST.	4. FACING FINISH	5. GLASS	6. FIRE RATING	7. FRAME TYPE	8. FRAME CONST.	HEAD	JAMB	SILL		
100a	4'-0"	7'-0"	FG	SHM	P	SG1	-	3	SHM	A1	B1	D1	-	
100b	4'-0"	7'-0"	F	SHM	P	SG1	-	3	SHM	C1 SIM.	C1	-	-	
101	3'-0"	7'-0"	F	SHM	P	-	-	0	SHM	C2 SIM.	C2	-	-	
102	3'-0"	7'-0"	F	HM	P	-	-	01	HM	C2 SIM.	C2	-	-	
106	3'-0"	7'-0"	F	SHM	P	-	-	02	SHM	C3	C3	-	-	

DOOR LEGEND

1. DOOR OPENING.
2. SEE DOOR TYPES THIS SHEET.
3. DOOR CONSTRUCTION:
HM = HOLLOW METAL
SHM = SECURITY HOLLOW METAL
4. FACING AND FINISH:
P = PAINTED
5. GLASS: SEE GLAZING TYPES BELOW.
6. FIRE RATING IN MINUTES
7. SEE DOOR FRAME TYPES THIS SHEET
8. FRAME CONSTRUCTION:
HM = HOLLOW METAL
SHM = SECURITY HOLLOW METAL
9. REMARKS:
1. --


DOOR TYPES

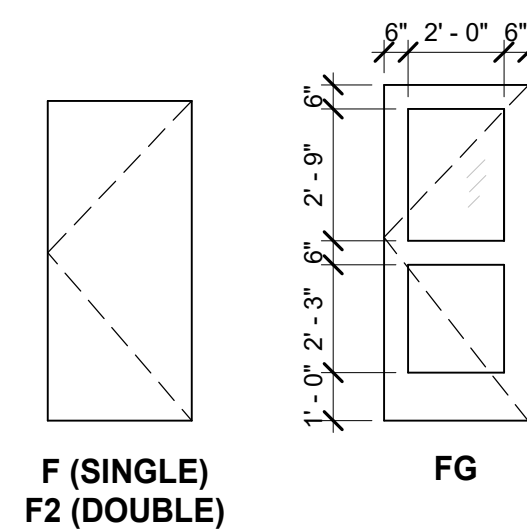

GLAZING TYPES


SG1:
11/16" GLASS CLAD POLYCARBONATE - SECURITY GRADE 3 - 3 PLY (20 MINUTE ATTACK) (SEE SPECIFICATION SECTION **088853**)

FRAME TYPES

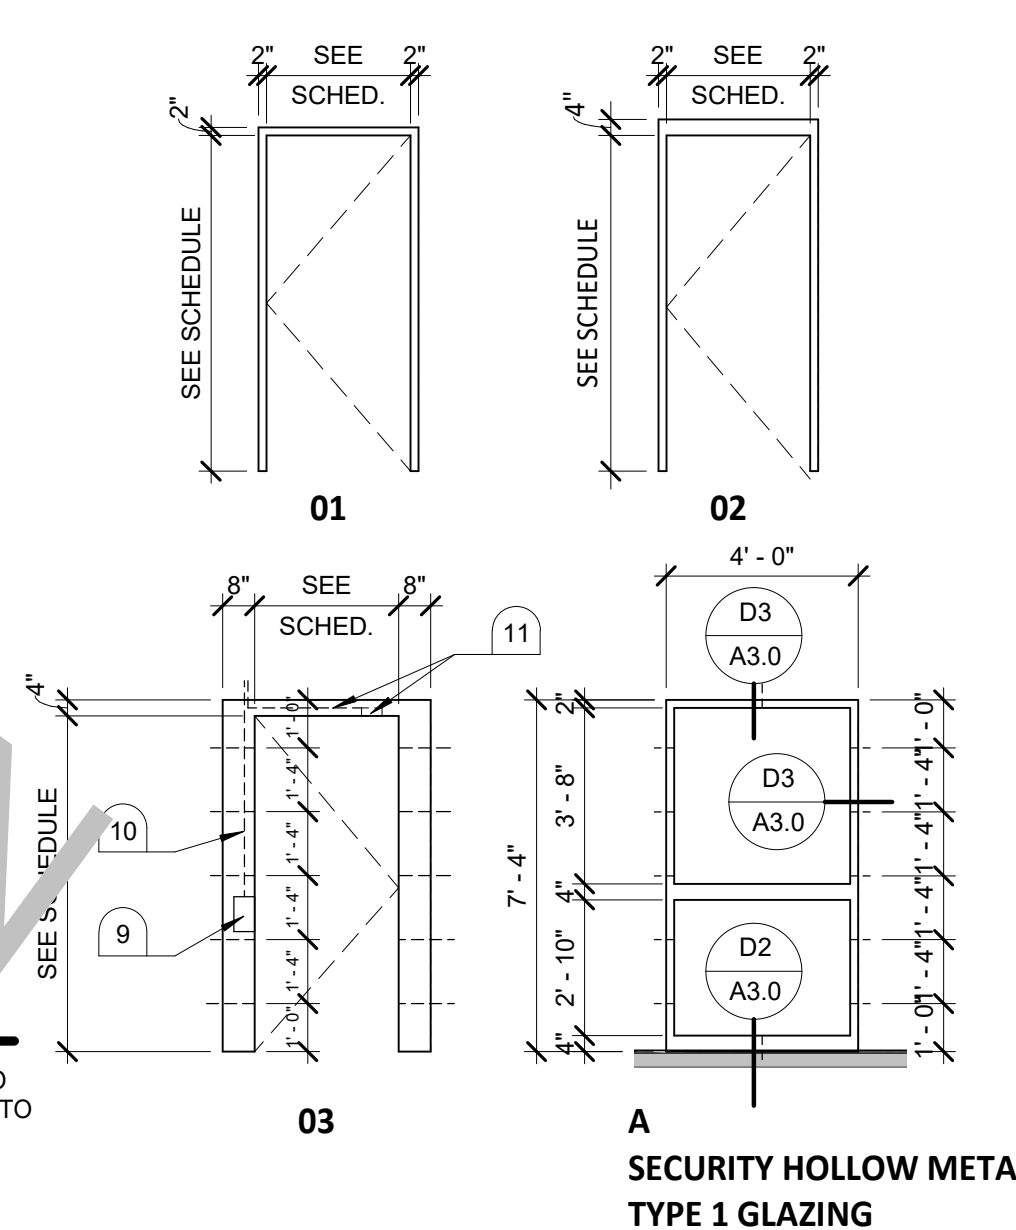

GENERAL DOOR NOTES

1. ALL DOORS AND WINDOWS SHALL BE CONSTRUCTED AS DETAILED. TO ACTUAL OPENING DIMENSIONS, FIELD VERIFY ALL DIMENSIONS PRIOR TO FABRICATION.
2. REFER TO SPEC SECTIONS **087100** OR **087163** FOR COMPLETE HARDWARE REQUIREMENTS AT EACH GROUP/OPENING.
3. PROVIDE TEMPERED GLASS IN DOORS, WINDOW LIGHTS, AND ADJACENT TO DOOR AND GLAZING WITHIN 36" FROM WALKING SURFACE AND TO MEET ALL OTHER REQUIREMENTS OF IBC SECTION 2406.

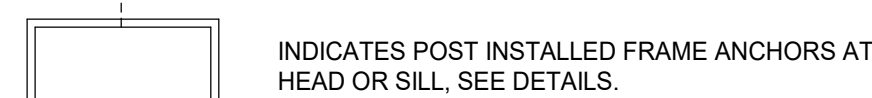

CONDOC

079200.A	JOINT SEALANT.
083463.A	DETENTION DOOR. SEE DOOR SCHEDULE
083463.B	DETENTION FRAME
083463.H	GLAZING STOP
087163.F	THRESHOLD
087163.F.1	DOOR BOTTOM
088853.A	SECURITY GLAZING
092216.A	STEEL STUD FRAMING.
092216.E	STEEL STUD TRACK / RUNNER.
092216.F.1	DEFLECTION TRACK.
092900.E	5/8" TYPE X ABUSE-RESISTANT GYPSUM BOARD.
092900.N	SOUND ATTENUATION BLANKETS.

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REMODEL - JCCN**

**DJC - JCC NAMPA
DPW PROJECT
#21535**

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DOOR SCHEDULE & DETAILS

SHEET NO.

A3.0

APPROVAL AREA

1

2

3

4

5

6

A

B

C

D

1

2


3

4

5


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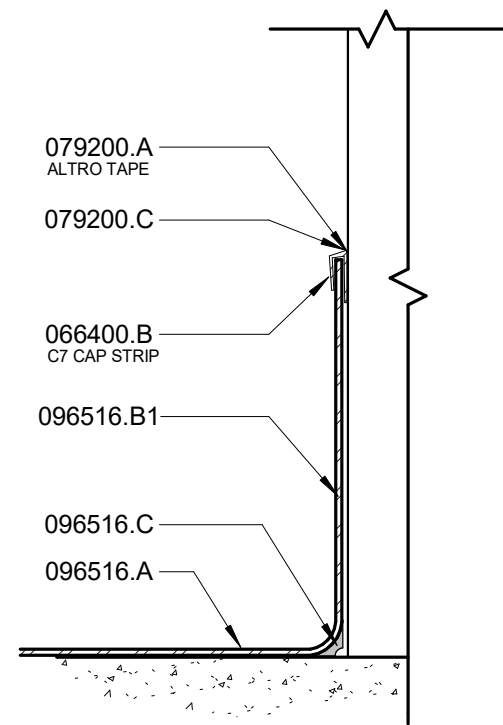
A5 FLOOR TRANSITIONS
12" = 1'-0"

ID001

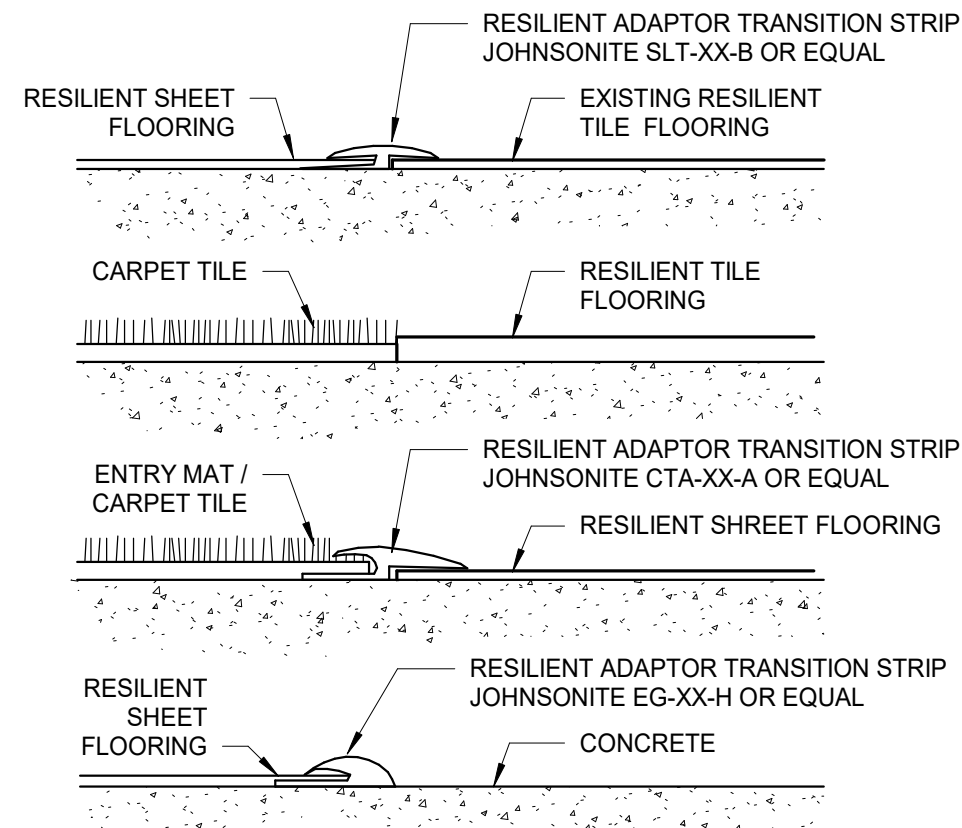


B5 INTEGRAL COVE BASE 1
3" = 1'-0"

ID002

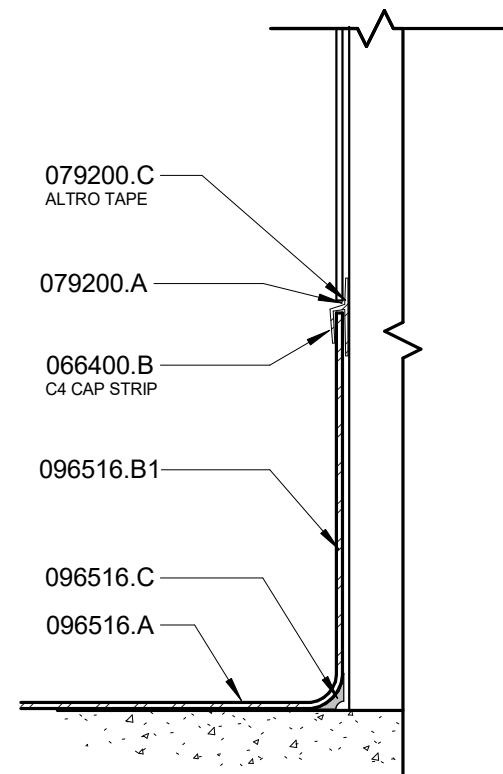


C5 INTERGAL COVE BASE 2
3" = 1'-0"

ID003

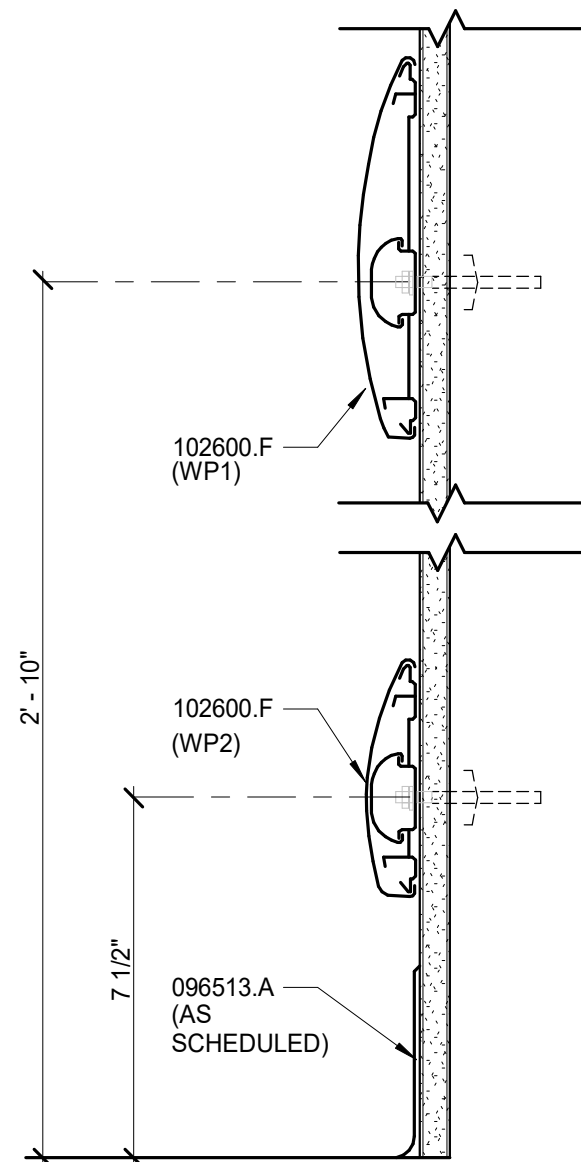

D4 DUAL WALL GUARD
3" = 1'-0"

ID005

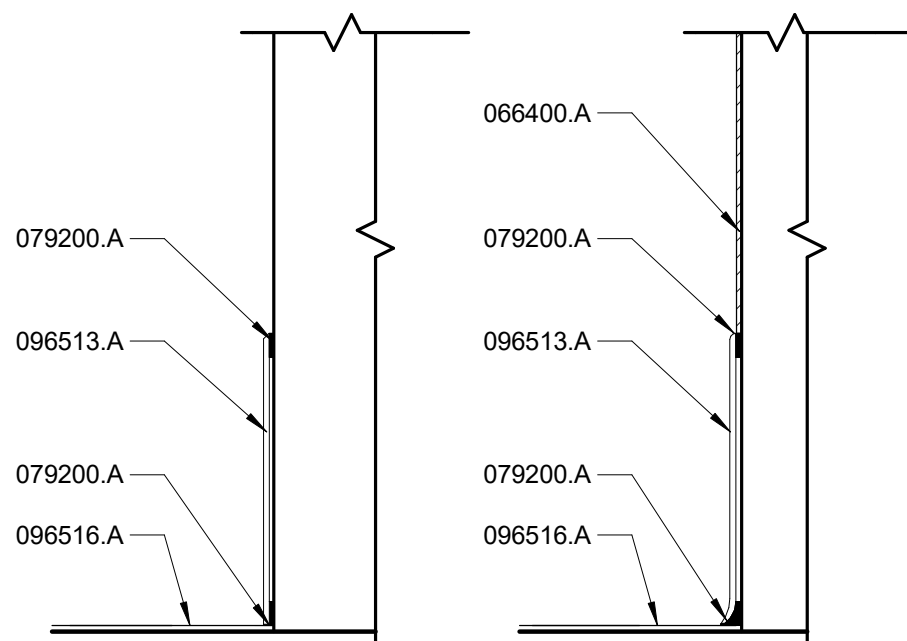

D5 RUBBER BASE
3" = 1'-0"

ID004

PLACE BEAD OF WATER RESISTANT SEALANT BEHIND BOTTOM EDGE OF RUBBER BASE ALLOWING EXCESS TO SEEP OUT. WIPE EXCESS SEALANT SMOOTH.

CONDOC

066400.A	PLASTIC SHEET PANELING.
066400.B	TRIM.
079200.A	JOINT SEALANT.
079200.C	BOND BREAKER TAPE.
096513.A	RESILIENT BASE.
096516.A	RESILIENT SHEET FLOORING.
096516.B1	6" INTEGRAL-FLASH-COVE-BASE.
096516.C	COVE STRIP.
102600.F	CHAIR RAIL.

KEYNOTES

- XXXX

GENERAL NOTES

- XXXXX

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INTERIOR
DETAILS

SHEET NO.

A4.0



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ENGINEERING, P.A.**
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208.384.0585

645 West 25th Street
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www.musgrovepa.com
PROJECT NO. 22-059

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IDAHO DPW - IDJC

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DEVELOPMENT**

ELECTRICAL
ENERGY
COMPLIANCE

SHEET NO.

E0.1

SYMBOL USED FOR CALLOUT

1. REMOVE EXISTING LIGHT FIXTURE. MAINTAIN AND PROTECT THE EXISTING CIRCUIT IN THIS AREA FOR RECONNECTION TO NEW FIXTURE. REFER TO LIGHTING PLAN.
2. REMOVE EXISTING LIGHT FIXTURE. MAINTAIN EXISTING CIRCUIT FOR EXTENSION TO NEW FIXTURES IN THIS AREA. REFER TO NEW WORK PLAN.
3. REMOVE EXISTING LIGHT FIXTURE. REMOVE CONDUIT AND CONDUCTORS BACK TO NEAREST DEVICE TO REMAIN.

STAMP-

PREFACE



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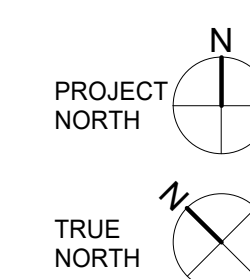
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ELECTRICAL DEMOLITION PLAN


SHEET NO. _____

E1.0



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PRELIMINARY

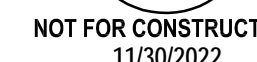

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IDAHO DPW - IDJC

CONSULTANT

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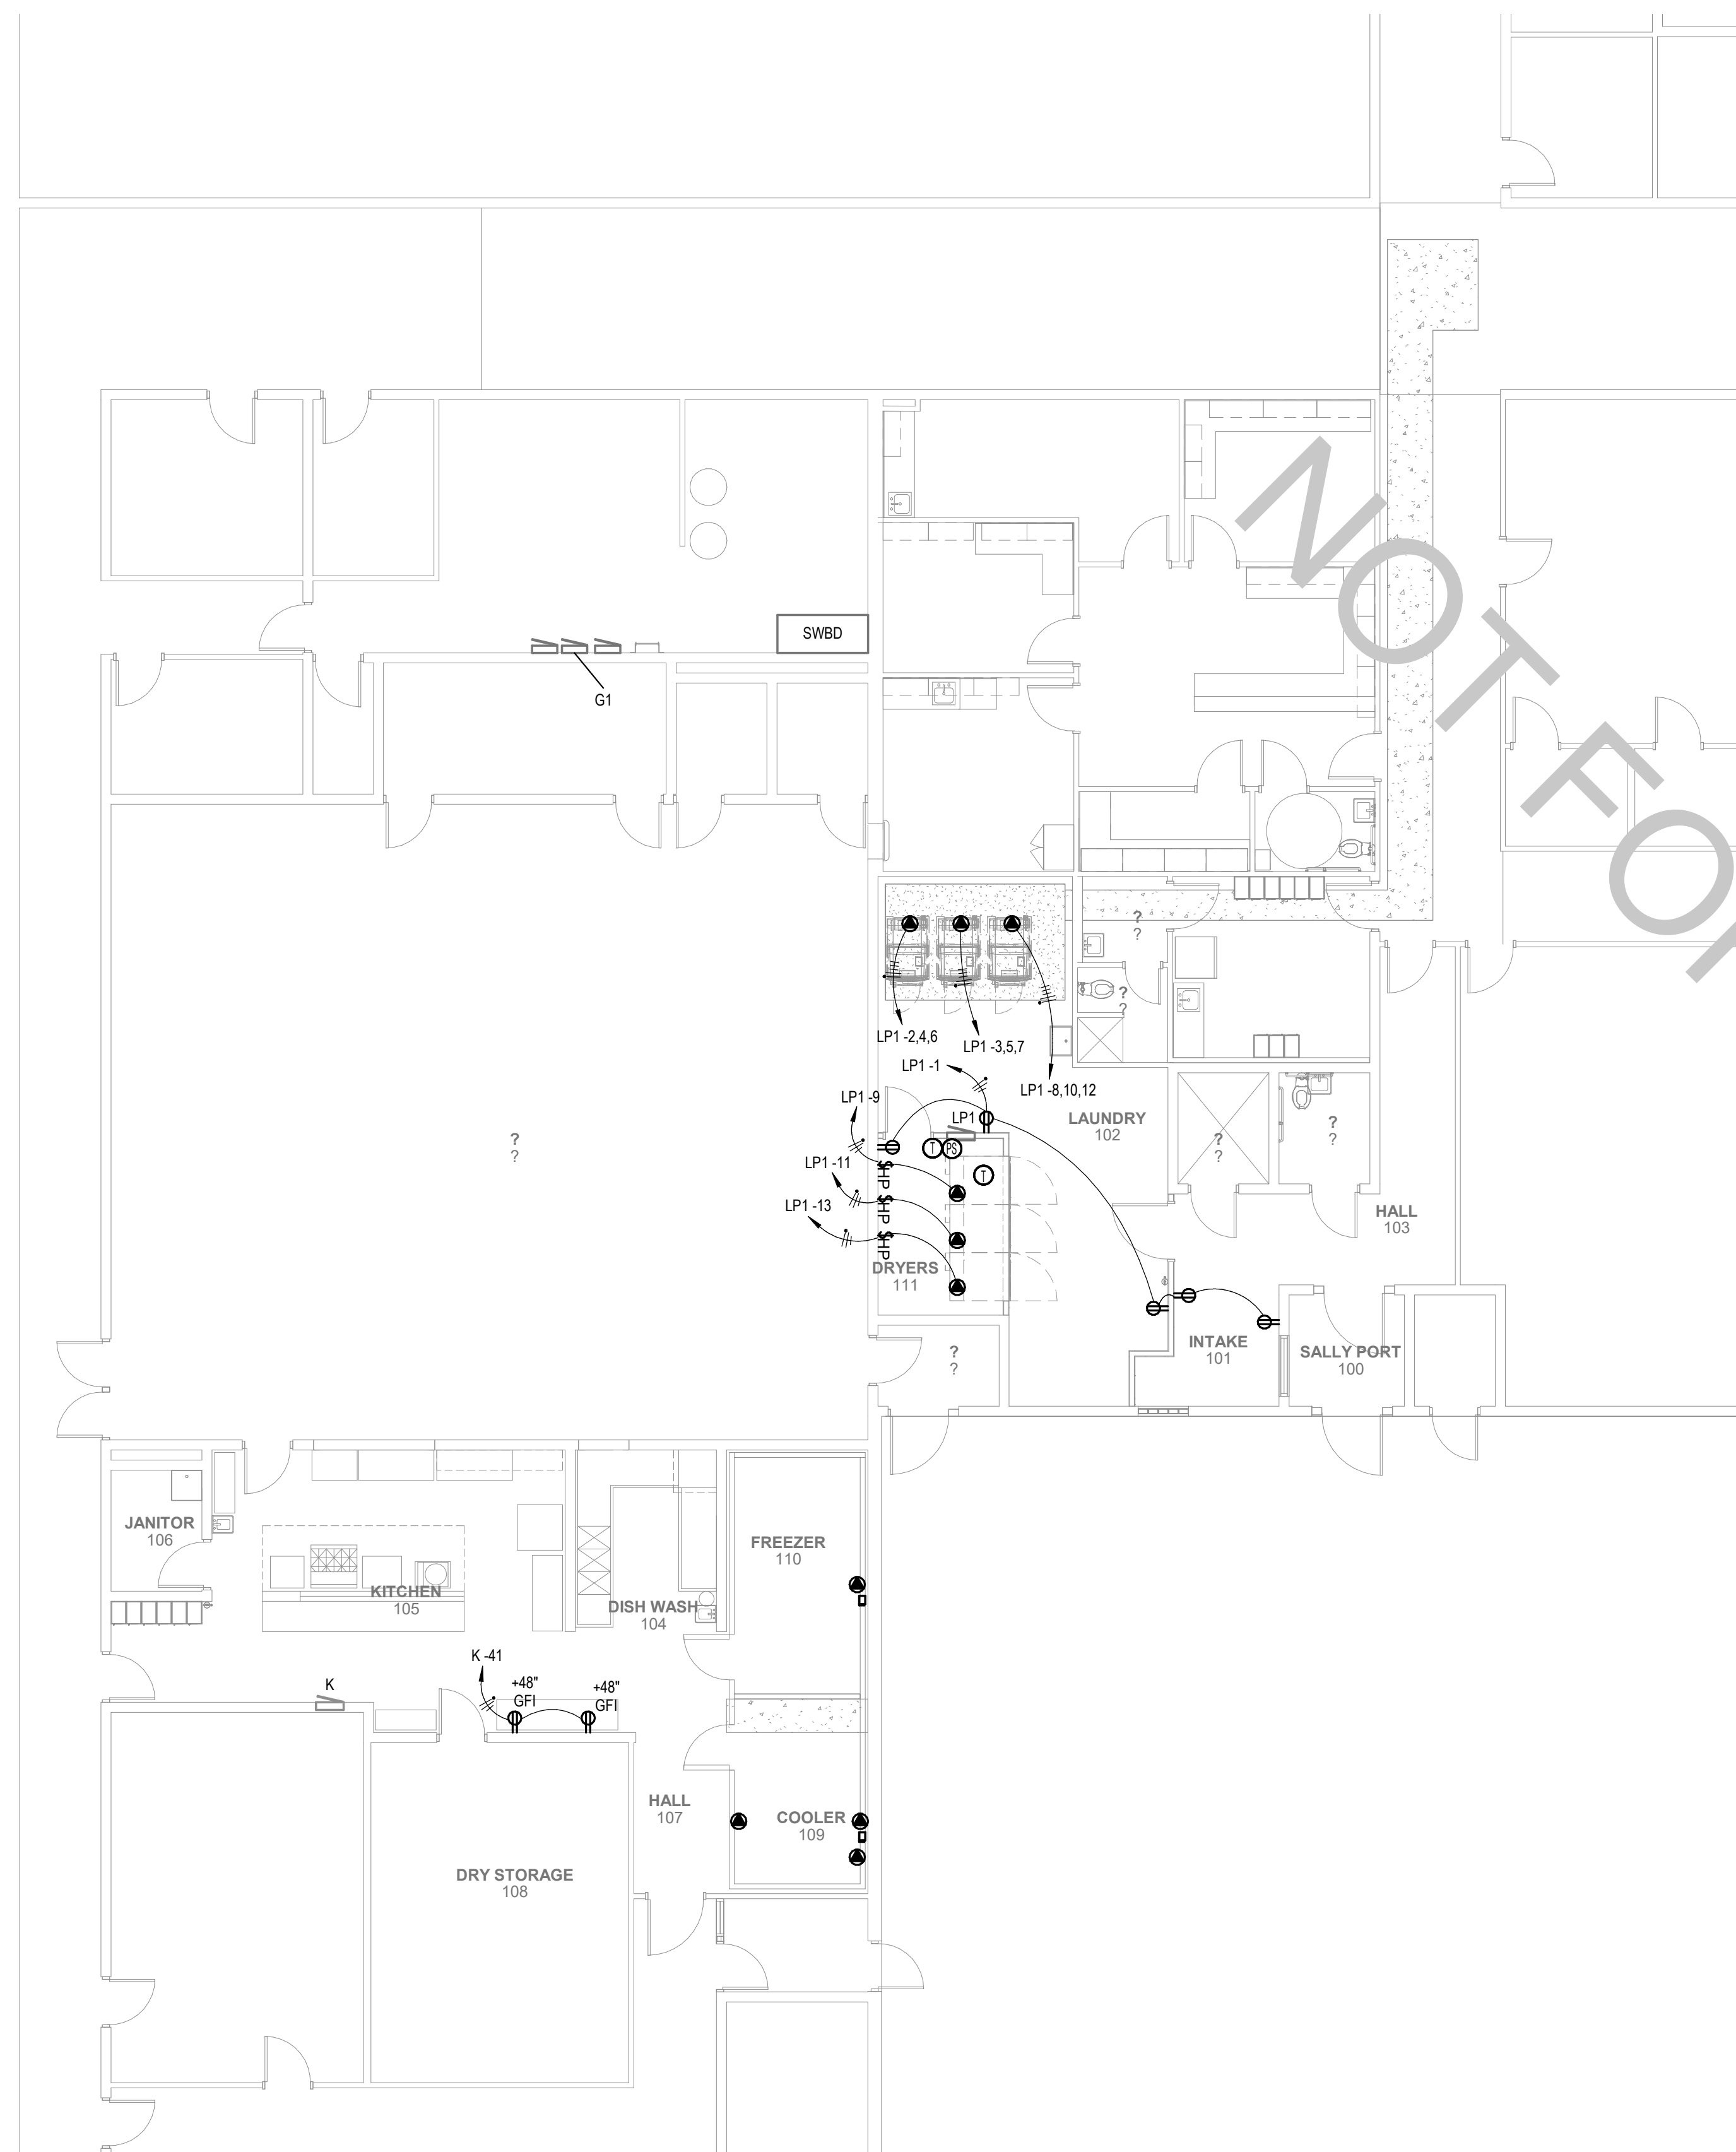
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PHASE: 100% DESIGN DEVELOPMENT

POWER PLAN

SHEET NO. _____

E2.1




1 POWER PLAN
1/8" = 1'-0"

SYMBOL USED FOR CALLOUT

1. INSTALL NEW LIGHT FIXTURE IN THE LOCATION OF THE REMOVED FIXTURE. RECONNECT THE FIXTURE TO THE EXISTING CIRCUIT AT THIS LOCATION.
2. INTERCEPT THE EXISTING CIRCUIT LEFT FROM THE REMOVAL OF THE EXISTING FIXTURES IN THIS AREA AND EXTEND TO NEW FIXTURES AS SHOWN. PROVIDE AND INSTALL ALL HARDWARE REQUIRED FOR A COMPLETE INSTALLATION.

STAMP-

PREFACE

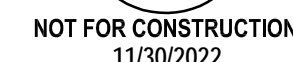

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REMODEL - JCCN**

IDAHO DPW - IDJC

CONSULTANT:

MRK	DATE	DESCRIPTION



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PHASE: 100% DESIGN DEVELOPMENT

LIGHTING PLAN

SHEET NO. _____


E2.2

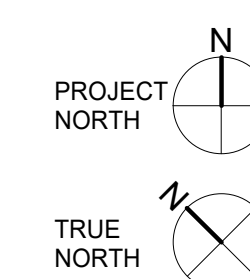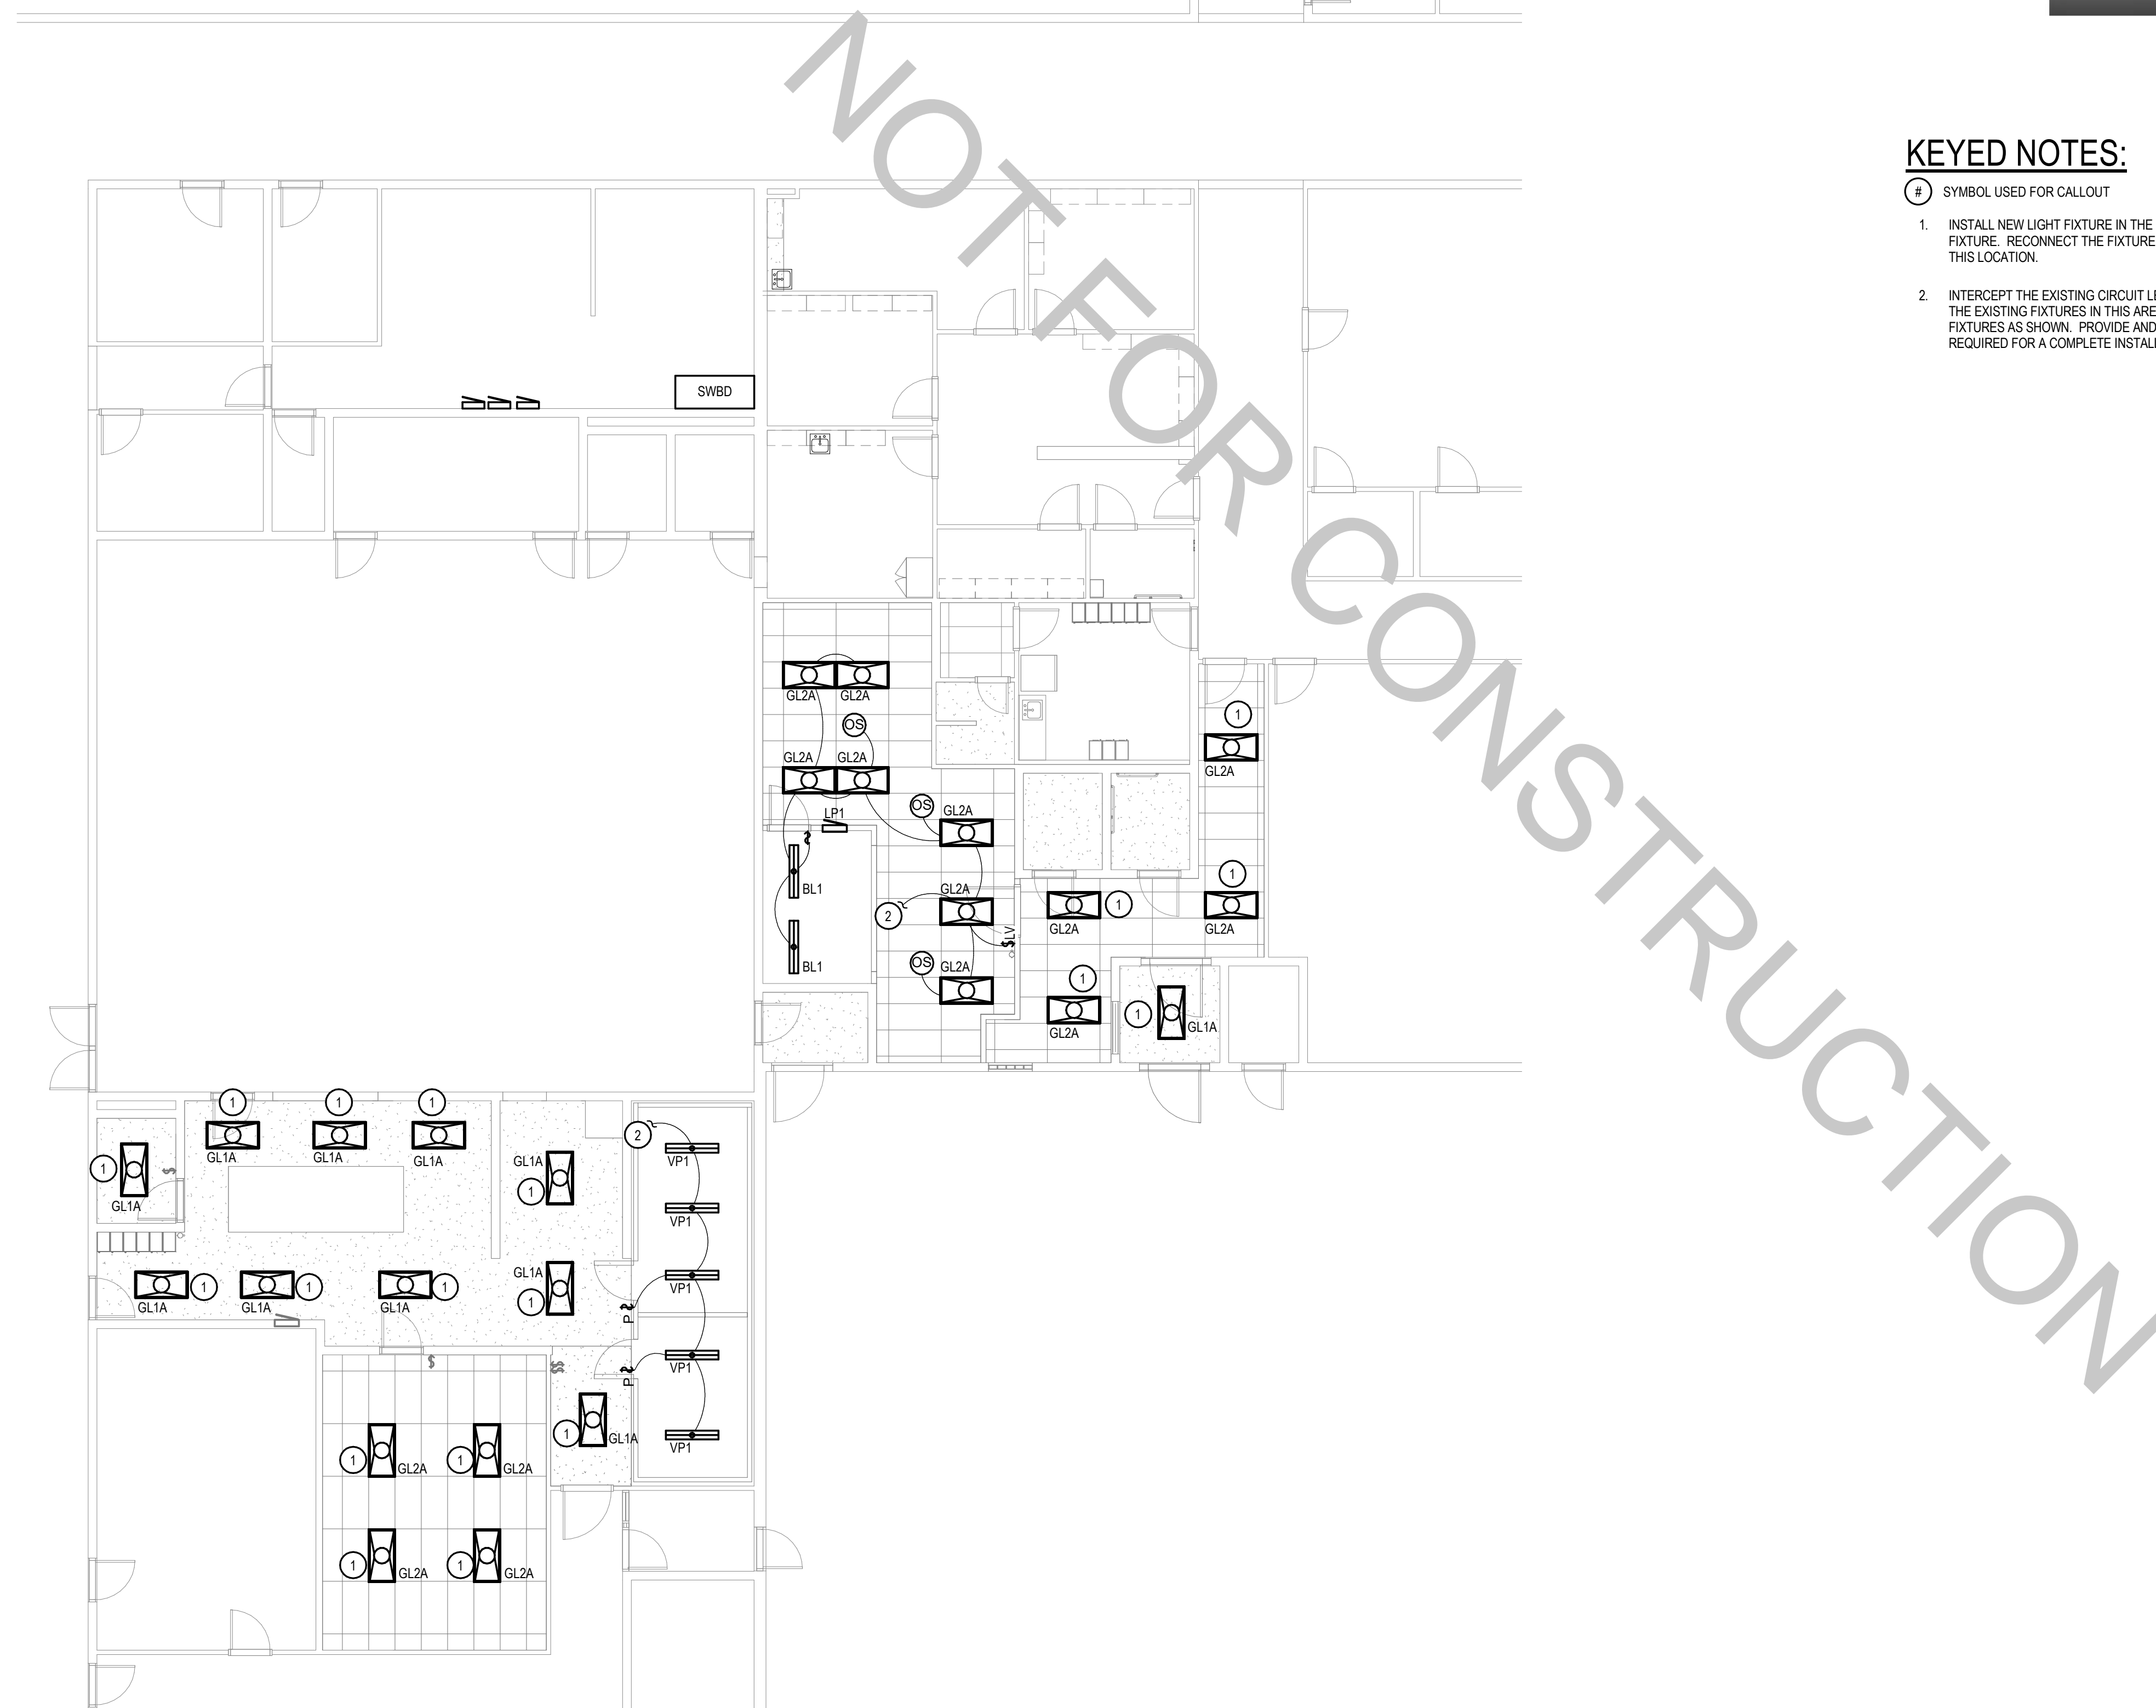

1 LIGHTING PLAN

STAMP-

PREFACE

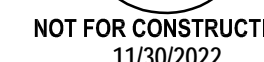

**DPW 21535 - IDJC
LAUNDRY &
KITCHEN
REMODEL - JCCN**

IDAHO DPW - IDJC

CONSULTANT

MRK	DATE	DESCRIPTION


JOB NO.: 22003.01
DATE: 08/03/22
DRAWN BY: Author
CHECKED BY: Checker

PHASE: 100% DESIGN DEVELOPMENT

SPECIAL SYSTEMS PLAN

SHEET NO. _____

E2.3

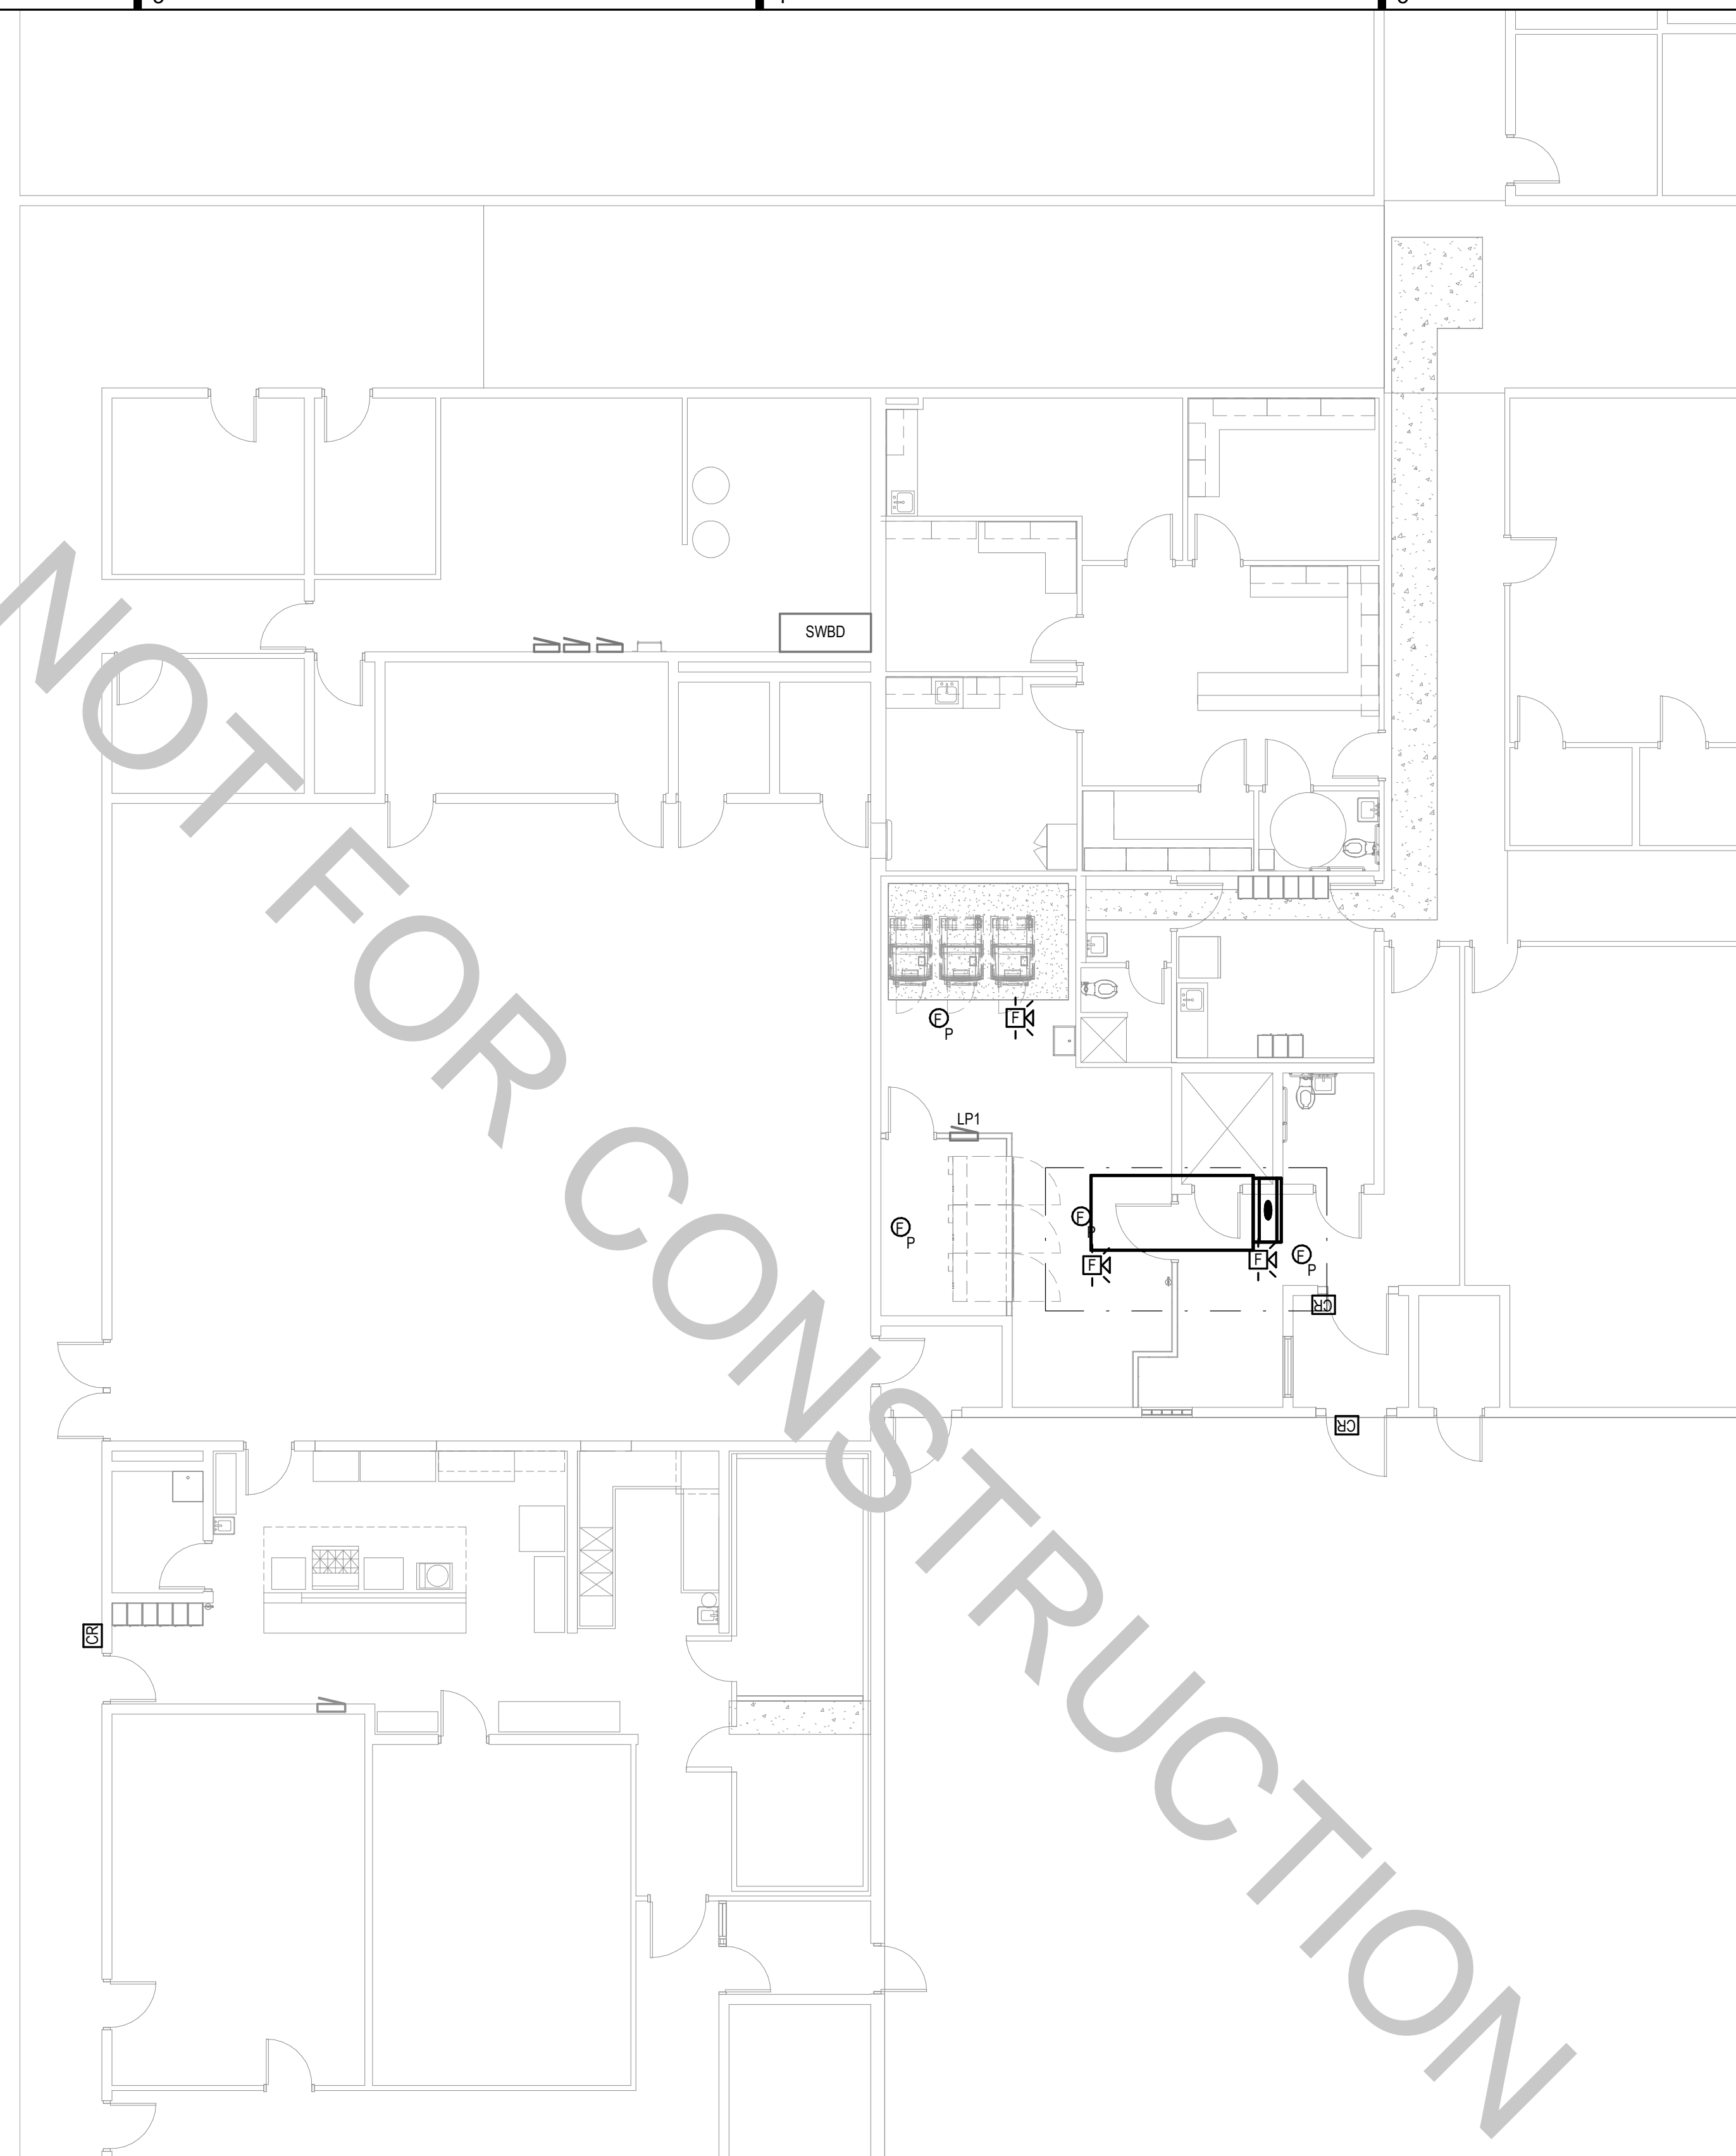


KEYED NOTES:

SYMBOL USED FOR CALLOUT

PROJECT NORTH

TRUE NORTH


1 SPECIAL SYSTEMS PLAN

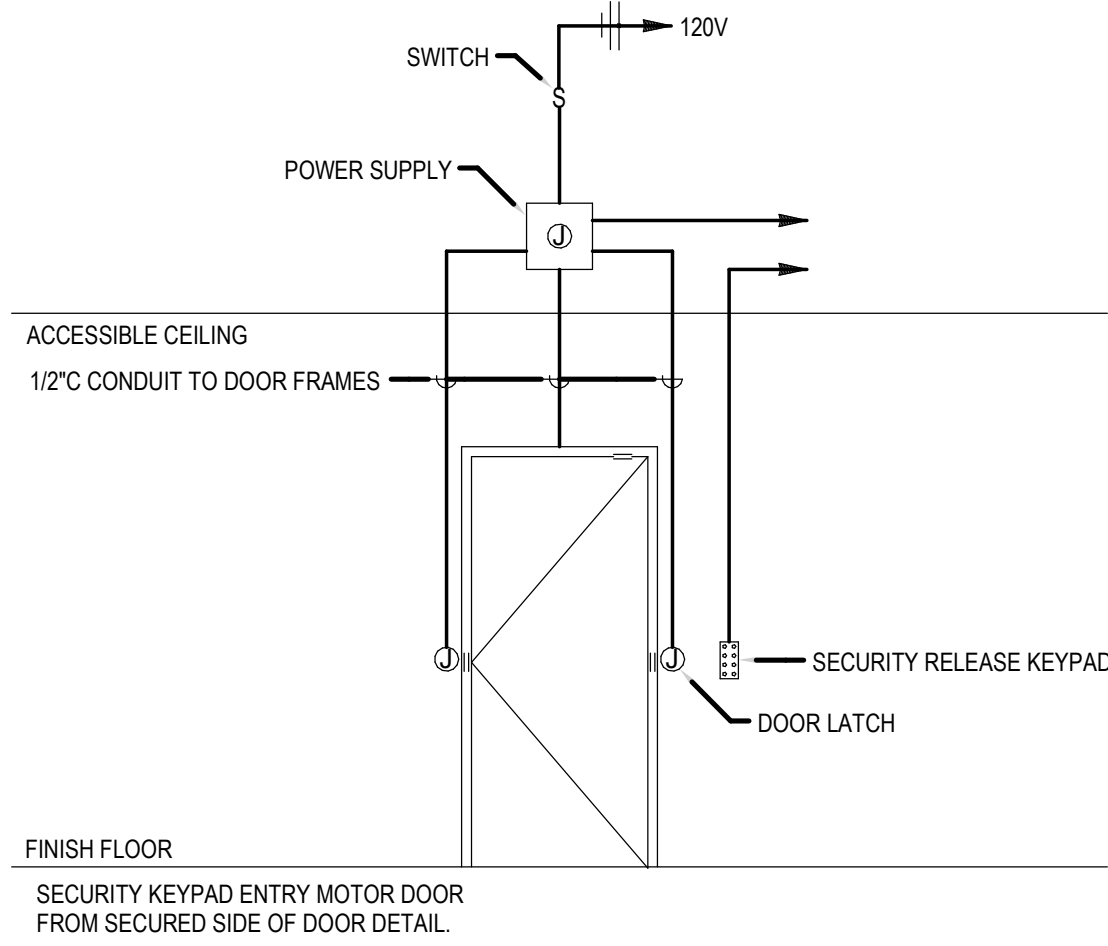

DETAIL GENERAL NOTES:

1. NOT USED

1 CARD READER DOOR DETAIL
NTS

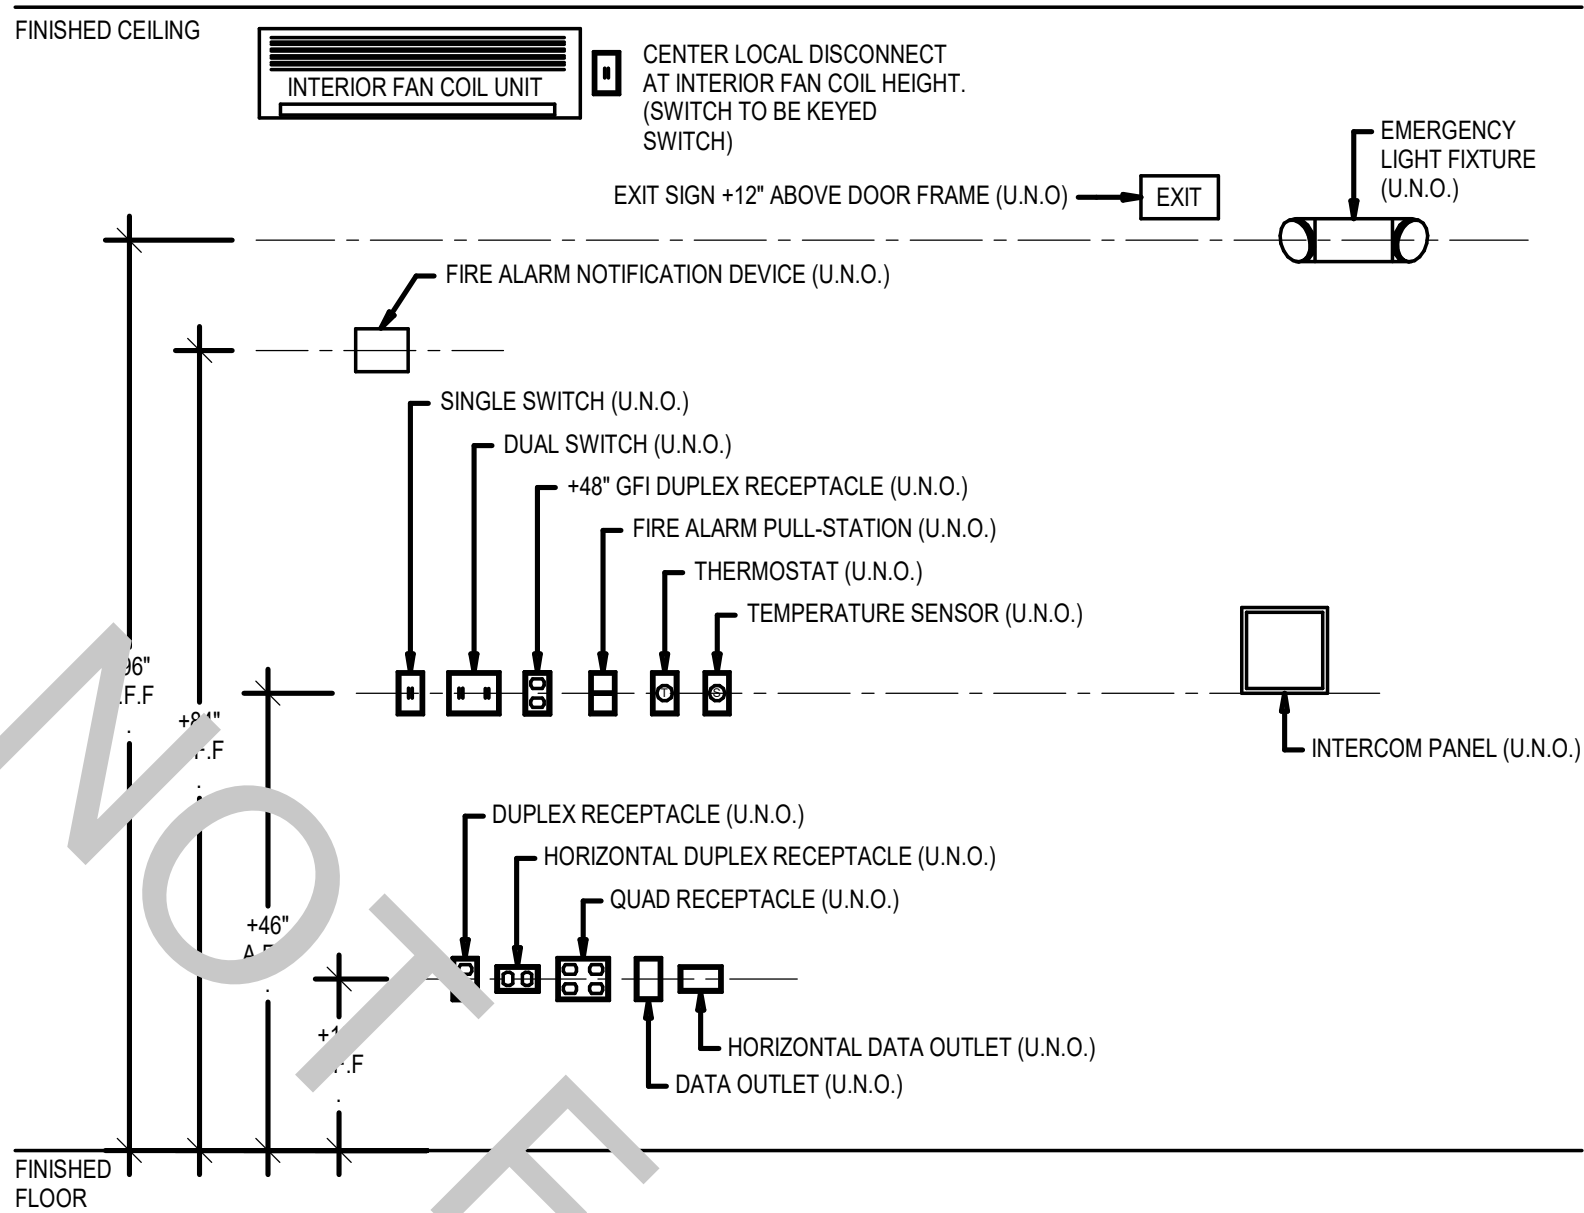

DETAIL GENERAL NOTES:

1. PROVIDE FRAMING AS REQUIRED.

2 STANDARD MOUNTING HEIGHTS
NTS

LIGHTING FIXTURE SCHEDULE

TYPE MARK	DESCRIPTION	MOUNTING	WATTAGE	LAMP	MANUFACTURER	MODEL	CEILING BY	NOTES
(D)	<varies>	Ceiling Grid	<varies>	<varies>	<varies>	<varies>		
BL1	4" LED STRIP	Surface	34.8W	34.8W LED, 5189 LUMENS, 3500K	LITHONIA	CLX-L48-5000LM-SEF-ULENS-MVOLT-EZ1-35K-80CRI-WH		LIGHTQUER/METAL UX/H.E. WILLIAMS
GL1A	SURFACE MOUNTED 2X4 LENSED LED	Ceiling Grid	31.7W	31.7W LED, 4000 LUMENS, 3500K	LITHONIA	2GTL-G-4-48L-EZ1-LP840-2X4SMKSHPPAF		LIGHTQUER/METAL UX/H.E. WILLIAMS
GL2A	GRID 2X4 LENSED LED	Ceiling Grid	31.7W	31.7W LED, 4000 LUMENS, 3500K	LITHONIA	2GTL-G-4-48L-EZ1-LP840		LIGHTQUER/METAL UX/H.E. WILLIAMS
VP1	4" LED VAPOR PROOF COOLER/FREEZER LIGHT	Surface	34.8W	34.8W LED, 5189 LUMENS, 3500K	LITHONIA	CSVT-48L-4000LM-MVOLT-40K-80CRI-STSL		LIGHTQUER/LITHONIA UX/H.E. WILLIAMS

LIGHTING FIXTURE SCHEDULE NOTES

- 1 SUBSTITUTIONS WILL BE ALLOWED IF SUBMITTED PRIOR TO BID DATE BY THE GREATER OF 7 BUSINESS DAYS OR THE TIME PERIOD SPECIFIED BY DIVISION 1 SPECIFICATIONS, AND IF DEEMED EQUAL BY THE ENGINEER. THE CONTRACTOR IS RESPONSIBLE FOR ENSURING SUBSTITUTED FIXTURES MEET OR EXCEED THE SPECIFICATIONS OF THE FIXTURES SPECIFIED.

Branch Panel: G1

Location: G1
Supply From: Mains Type: LUG
Mounting: Surface
Enclosure: Type 1

Volts: 120/208 Wye
Phases: 3
Wires: 4

A.I.C. Rating:
Mains Type: LUG
Mains Rating: 225 A
MCB Rating:

Notes:

CKT	Circuit Description	Ckt Note s	Trip	Poles	A	B	C	Poles	Trip	Ckt Note s	Circuit Description	CKT
1	(E)LOAD		20 A	1	600 VA	600 VA		1	20 A		(E)LOAD	2
3	(E)LOAD		20 A	1		600 VA	450 VA	1	20 A		(E)REC - ADMIN CONF RM	4
5	(E)REC - RM 103		20 A	1			360 VA	600 VA	1	20 A	(E)LOAD	6
7	(E)REC - RM 110-112		20 A	1	600 VA	600 VA		1	20 A		(E)REC - RM 118, 120	8
9	(E)REC - RM 114, 109		20 A	1		600 VA	600 VA	1	20 A		(E)REC - RM 114-116	10
11	(E)REC - RM 147, 150, 158		20 A	1			600 VA	600 VA	1	20 A	(E)REC - RM 123, 124, 126	12
13	(E)REC - RM 154, 162		20 A	1	600 VA	600 VA		1	20 A		(E)REC - RM 174, 176, 177	14
15	(E)REC - RM 163		20 A	1		360 VA	600 VA	1	20 A		(E)REC - RM 171, 173	16
17	(E)REC - RM 163		20 A	1			360 VA	600 VA	1	20 A	(E)LOAD	18
19	(E)REC - RM 163		20 A	1	360 VA	360 VA		1	20 A		(E)REC - OLD ENTRY COMPUTER	20
21	(E)REC - RM 163		20 A	1		360 VA	0 VA	1	20 A		Spare	22
23	Spare		20 A	1			0 VA	0 VA	1	20 A	Spare	24
25	Spare		20 A	1	0 VA	0 VA			1	20 A	Spare	26
27	Spare		20 A	1		0 VA	0 VA		1	20 A	Spare	28
29	Spare		20 A	1			0 VA	0 VA	1	20 A	Spare	30
31	Spare		20 A	1	0 VA	0 VA			1	20 A	Spare	32
33	Spare		20 A	1		0 VA	0 VA		1	20 A	Spare	34
35	Spare		20 A	1			0 VA	0 VA	1	20 A	Spare	36
37	Spare		20 A	1	0 VA	0 VA			1	20 A	Spare	38
39	Spare		20 A	1		0 VA	0 VA		1	20 A	Spare	40
41	Spare		20 A	1			0 VA	0 VA	1	20 A	Spare	42
Total Load:					4320 VA	3570 VA	3120 VA					
Total Amps:					37 A	30 A	26 A					

Legend:

Branch Panel: LP1

Location: LP1
Supply From: Mains Type: LUG
Mounting: Recessed
Enclosure: Type 1

Volts: 120/208 Wye
Phases: 3
Wires: 4

A.I.C. Rating:
Mains Type: LUG
Mains Rating: 225 A
MCB Rating:

Notes:

CKT	Circuit Description	Ckt Note s	Trip	Poles	A	B	C	Poles	Trip	Ckt Note s	Circuit Description	CKT
1	REC - LAUNDRY, INTAKE		20 A	1	720 VA	960 VA		1	20 A		WASHING MACHINE 1	2
3	WASHING MACHINE 2		20 A	3		960 VA	960 VA		3	20 A		4
5			--	--			960 VA	960 VA	--	--		6
7			--	--	960 VA	960 VA			3	20 A	WASHING MACHINE 3	8
9			15 A	1					--	--		10
11	DRYER 2		15 A	1					--	--		12
13	DRYER 3		15 A	1	1176 VA		1176 VA	960 VA	--	--		14
15												16
17												18
19												20
21												22
23												24
25												26
27												28
29												30
31												32
33												34
35												36
37												38
39												40
41												42
Total Load:					4776 VA	4056 VA	4056 VA					
Total Amps:					40 A	34 A	34 A					

Legend:



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645 West 25th Street
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www.musgrovepa.com
PROJECT NO. 22-059

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STAMP:



DPW 21535 - IDJC
LAUNDRY &
KITCHEN
REMODEL - JCCN

IDAHO DPW - IDJC

CONSULTANT:

DESCRIPTION
DATE
MRK

JOB NO.: 22003.01
DATE: 11/30/22
DRAWN BY: Author
CHECKED BY: Checker

PHASE: 100% DESIGN
DEVELOPMENT

ELECTRICAL
DETAILS /
SCHEDULES

SHEET NO.

E3.0



MECHANICAL ABBREVIATIONS			
A/C or AC	AIR CONDITIONING	KW	KILOWATT
AF	ABOVE FINISHED FLOOR	KWH	KILOWATT HOUR
AHU	AIR HANDLING UNIT		
ASHRAE	AMERICAN SOCIETY OF HEATING, REFRIGERATION, AND AIR CONDITIONING ENGINEERS	LAT	LEAVING AIR TEMPERATURE
BTU	BRITISH THERMAL UNITS	LAV	LAVATORY
BTUH	BTUS PER HOUR	LEED	LEADERSHIP IN ENERGY AND ENVIRONMENTAL DESIGN
		LWT	LEAVING WATER TEMPERATURE
CA	COMBUSTION AIR	MAX	MAXIMUM
CC	COOLING COIL	MCA	MINIMUM CIRCUIT AMPS
CFM	AIR FLOW RATE (CUBIC FEET PER MINUTE)	MOCP	MAXIMUM OVERCURRENT PROTECTION
CHWR	CHILLED WATER RETURN	MIN	MINIMUM
CHWS	CHILLED WATER SUPPLY	NC	NOISE CRITERIA
CLG	CEILING	NFPA	NATIONAL FIRE PROTECTION ASSOCIATION
CW	COLD WATER	NTS	NOT TO SCALE
DEG or °	DEGREE	OSA	OUTSIDE AIR
DIA or Ø	DIAMETER	PD	PRESSURE DROP
DB	DRY BULB	PH or Ø	PHASE
EA	EXHAUST AIR	PRV	PRESSURE REDUCING VALVE
EER	ENTERING AIR TEMPERATURE	RA	RETURN AIR
ESP	EXTERNAL STATIC PRESSURE	RPM	REVOLUTIONS PER MINUTE
EWT	ENTERING WATER TEMPERATURE	RTU	ROOFTOP UNIT
FCO	FLOOR CLEANOUT	SA	SUPPLY AIR
FD	FIRE DAMPER	SEER	SEASONAL ENERGY EFFICIENCY RATIO
FLA	FULL LOAD AMPS	SFD	COMBINATION SMOKE/FIRE DAMPER
FLR	FLOOR	SP	STATIC PRESSURE
FFM	FEET PER MINUTE	SYM	SYMBOL
FT	FEET		
GA	GAUGE	T & P	TEMPERATURE AND PRESSURE
GCO	GRADE CLEANOUT	TEMP	TEMPERATURE
GPM	WATER FLOW RATE (GALLONS PER MINUTE)	TYP	TYPICAL
HC	HEATING COIL	UMC	UNIFORM MECHANICAL CODE
HP	HORSE POWER	UPC	UNIFORM PLUMBING CODE
HVAC	HEATING, VENTILATING, AIR CONDITIONING	URL	URINAL
HW	HOT WATER	V	VENT THROUGH ROOF
HWR	HOT WATER RETURN	VTR	VENT THROUGH ROOF
HWS	HOT WATER SUPPLY	V	VOLTS
IBC	INTERNATIONAL BUILDING CODE	W/	WITH
IEEC	INTERNATIONAL ENERGY CONSERVATION CODE	WB	WET-BULB
IPC	INTERNATIONAL FIRE CODE	WC	WATER CLOSET
IFGC	INTERNATIONAL FUEL GAS CODE	WCO	WALL CLEANOUT
IMC	INTERNATIONAL MECHANICAL CODE	WH	WATER HEATER
IPC	INTERNATIONAL PLUMBING CODE		
NOTE: THIS IS A STANDARD LIST OF COMMONLY USED MECHANICAL ABBREVIATIONS. SOME OF THE ABBREVIATIONS SHOWN ABOVE MAY NOT BE USED IN THIS DRAWING PACKAGE.			

MECHANICAL GENERAL NOTES	
1.	ALL MECHANICAL EQUIPMENT AND SYSTEMS SHALL BE INSTALLED IN ACCORDANCE WITH THE INTERNATIONAL MECHANICAL CODE (IMC) LATEST EDITION, AND ALL APPLICABLE LOCAL AND STATE CODES.
2.	ALL PLUMBING EQUIPMENT AND SYSTEMS SHALL BE INSTALLED IN ACCORDANCE WITH THE LATEST ADOPTED PLUMBING CODE, AND ALL LOCAL AND STATE CODES.
3.	ALL MECHANICAL AND PLUMBING EQUIPMENT SHALL BE INSTALLED PER THE MANUFACTURER'S RECOMMENDATIONS.
4.	MECHANICAL CONTRACTORS SHALL RECEIVE PRIOR APPROVAL FROM THE STRUCTURAL ENGINEER BEFORE MAKING CUTS THROUGH ANY STRUCTURAL MEMBER.
5.	MECHANICAL CONTRACTORS SHALL COORDINATE INSTALLATION WITH CONSTRUCTION SUPERVISOR AND WITH ALL OTHER TRADES TO AVOID CONFLICTS.
6.	THE MECHANICAL CONTRACTORS SHALL VERIFY MOTOR VOLTAGES WITH THE ELECTRICAL DRAWINGS PRIOR TO ORDERING MOTORIZED EQUIPMENT AND CONTROLS.
7.	SEE MECHANICAL SCHEDULE SHEET FOR SCHEDULED CAPACITIES OF ALL MECHANICAL EQUIPMENT AND MATERIALS SPECIFIED.
8.	DOMESTIC WATER SERVICE IS PROVIDED WITH A DOUBLE-CHECK BACKFLOW PREVENTER ASSEMBLY.
9.	THE PLUMBING CONTRACTOR IS RESPONSIBLE FOR ALL BACKFLOW DEVICES TO INSPECTED BY A CERTIFIED BACKFLOW TECHNICIAN BEFORE THE USE OF THE BUILDING POTABLE WATER SYSTEM.
10.	ALL MECHANICAL EQUIPMENT TO BE PROPOSED MUST BE ON THE APPROVED LIST PRIOR TO SUBMITTALS. ALL APPROVED MANUFACTURERS MUST BE CAPABLE OF MEETING THE REQUIREMENTS OF THE SPECIFIED EQUIPMENT.
11.	RUNOUT AND HOOKUP SIZES TO INDIVIDUAL PLUMBING FIXTURES CAN BE FOUND ON THE PLUMBING FIXTURE SCHEDULE.
12.	PROVIDE REMOTE CEILING ACCESS BALANCE DAMPERS WITH CONCEALED CHROME PLATE COVERS FOR BALANCE DAMPERS LOCATED ABOVE HARD CEILINGS.
13.	PAINT VTRS, FLUES, EXHAUST CAPS, AND OTHER MECHANICAL ITEMS ON THE ROOF TO MATCH THE ROOF COLOR.
14.	INSULATED FLEXIBLE DUCTWORK--IN LENGTHS OF 6'-0" OR LESS--MAY BE USED FOR RUNOUTS TO AIR TERMINALS.
15.	MAINTAIN MINIMUM 10'-0" DISTANCE BETWEEN ALL FRESH AIR INTAKES AND EXHAUST OR GAS FLUE DISCHARGES.
16.	LOCATE ACCESS HATCHES SO AS TO PROVIDE OPTIMUM SERVICEABILITY TO EQUIPMENT AND/OR VALVING. SEE ARCHITECTURAL SPECIFICATION FOR TYPE AND COLOR. COORDINATE LOCATION WITH ARCHITECTURAL, STRUCTURAL, AND LIGHTING.
17.	WHENEVER THERE IS A DISCREPANCY BETWEEN THE RUNOUT DUCT SIZE SHOWN ON THE PLANS AND THAT SHOWN IN THE SCHEDULE, ALWAYS USE THE LARGER OF THE TWO DUCT SIZES.
18.	THE CONTRACTOR SHALL BE HELD RESPONSIBLE FOR VERIFICATION OF EXISTING JOB CONDITIONS PRIOR TO BID. NO ADDITIONAL COST SHALL BE AWARDED TO THE SUCCESSFUL CONTRACTOR (OR THEIR SUBCONTRACTORS) AFTER BIDS HAVE BEEN SUBMITTED AND CONTRACTS AWARDED FOR FAILURE TO VERIFY EXISTING FIELD CONDITIONS. DISCREPANCIES BETWEEN ACTUAL FIELD CONDITIONS AND CONTRACT DOCUMENTS SHALL BE BROUGHT TO THE ATTENTION OF THE ENGINEER FOR ALTERNATIVE METHODS OF INSTALLATION PRIOR TO THE BIDDING OF THIS PROJECT.
19.	UNLESS OTHERWISE NOTED, ALL EXISTING MECHANICAL EQUIPMENT, PIPING, ETC. TO BE REMOVED SHALL BE DISPOSED OF BY THE CONTRACTOR UNDER THIS CONTRACT. THE OWNER SHALL RETAIN THE RIGHT TO KEEP ANY REMOVED ITEMS.
20.	ALL DOMESTIC HOT AND COLD WATER LINES IN THE AREA OF WORK WHICH ARE NO LONGER IN USE DUE TO THIS PROJECT SHALL BE REMOVED BACK TO THE MAINS AND CAPPED. NO DEAD LEGS ALLOWED.
21.	HOLES IN EXISTING WALLS OR FLOORS SHALL BE PATCHED TO MATCH EXISTING WHERE PIPING, DUCTWORK, ETC., WERE REMOVED OR ADDED DURING THIS PROJECT.
22.	DAMAGE TO THE EXISTING FACILITY DURING THE CONSTRUCTION OF THIS PROJECT SHALL BE REPAIRED OR REPLACED BY THE CONTRACTOR AT NO COST THE OWNER.

MECHANICAL AND PLUMBING DRAWINGS LEGEND			
	FLEXIBLE DUCTWORK		THREE WAY CONTROL VALVE
	DUCTWORK		TWO WAY CONTROL VALVE
	DUCTWORK BREAK		PRESSURE REDUCING VALVE
	DUCTWORK OR PIPING RISE		GATE VALVE
	CONCENTRIC SQUARE TO ROUND TRANSITION		REDUCER
	MOTORIZED DAMPER		GLOBE VALVE
	MANUAL VOLUME DAMPER		BALL VALVE
	SPIN-IN FITTING W/ AIR EXTRACTOR AND HAND DAMPER		BUTTERFLY VALVE
	HIGH EFFICIENCY FITTING W/ HAND DAMPER		BALANCE VALVE
	SWITCH		CHECK VALVE
	THERMOSTAT		FLOOR CLEANOUT
	HUMIDISTAT		WALL CLEANOUT
	TEMPERATURE SENSOR		GRADE CLEANOUT
	CARBON DIOXIDE SENSOR		WATER HAMMER ARRESTOR
	CARBON MONOXIDE SENSOR		FLOOR DRAIN
	NITROUS OXIDE SENSOR		FLOOR SINK
	DUCT SMOKE DETECTOR		GAS PRESSURE REGULATOR W/ GAS COCK
	COMBINATION SMOKE/FIRE DAMPER		PRESSURE RELIEF VALVE
	FIRE DAMPER		VENT-THROUGH-ROOF
	SMOKE DAMPER		VENT
	EQUIPMENT CLEANOUT		SOIL, WASTE, OR SANITARY SEWER
	TURNING VANES		ACID WASTE LINE
	INTAKE OR EXHAUST		ACID VENT LINE
	DIRECTION OF AIRFLOW		STORM DRAIN
	SUPPLY DIFFUSER		ROOF DRAIN LINE
	RETURN GRILLE		OVERFLOW DRAIN LINE
	EXHAUST GRILLE		COMPENSATE DRAIN LINE
	FLOOR GRILLE		DOMESTIC COLD WATER (CW)
	CEILING EXHAUST FAN		DOMESTIC HOT WATER (HW)
	TEMPERATURE GAUGE		DOMESTIC HOT WATER RETURN (HWR)
	PRESSURE GAUGE (LIQUID FILLED W/ ISOLATION VALVE)		TEMPERED WATER (TW)
	TEMPERATURE SENSOR (DUCT OR PIPING)		MEDIUM PRESSURE NATURAL GAS
	FLOW SWITCH		LOW PRESSURE NATURAL GAS
	STAINLESS STEEL BRAIDED FLEX CONNECTION		FIRE SPRINKLER LINE
	ELASTOMETRIC FLEX CONNECTOR		GEO THERMAL WATER SUPPLY
	SUCTION DIFFUSER		GEO THERMAL WATER RETURN
	Y TYPE STRAINER (1-1/2" OR LARGER PROVIDED W/ BLOW DOWN VALVE)		CHILLED WATER SUPPLY
	FLOW DIRECTION		CHILLED WATER RETURN
	DEMOLITION / EQUIPMENT TO BE REMOVED		CONDENSER WATER SUPPLY
	NEW TO EXISTING CONNECTION POINT		CONDENSER WATER RETURN
	EXISTING		HEATING WATER SUPPLY
	FUTURE		HEATING WATER RETURN
	NEW		LIQUID REFRIGERANT LINE
	REDUCED PRESSURE BACKFLOW PREVENTER		SUCTION REFRIGERANT LINE
	DOUBLE CHECK BACKFLOW PREVENTER		SLOPE PIPE IN DIRECTION OF ARROW
	UNION		PIPE ANCHOR
	AIR VENT		PIPE GUIDE
	TRIPLE DUTY VALVE		CAP
NOTE: THIS IS A LIST OF COMMONLY USED MECHANICAL AND PLUMBING SYMBOLS. SOME OF THE SYMBOLS SHOWN ABOVE MAY NOT BE USED IN THIS DRAWING PACKAGE.			

ENERGY CODE COMPLIANCE	
A.	COMPLIANCE WITH THE LATEST ADOPTED EDITION OF THE INTERNATIONAL ENERGY CONSERVATION CODE IS REQUIRED FOR THIS PROJECT. THESE NOTES COVER MANDATORY REQUIREMENTS OF THE CODE. ADDITIONAL REQUIREMENTS ARE NOTED ON THE DRAWINGS AND IN THE SPECIFICATIONS.
B.	MINIMUM REQUIREMENTS FOR SUPPLY AND RETURN DUCTWORK INSULATION: 1. R-6: DUCTS LOCATED IN UNCONDITIONED SPACES (SPACE NEITHER HEATED NOR COOLED SUCH AS ABOVE CEILING SPACES, WALL SPACES, DUCT CHASES, SOFFITS, ATTICS, CRAWL SPACES, UNHEATED BASEMENTS, AND UNHEATED GARAGES). 2. R-12: DUCTS LOCATED OUTSIDE OF THE BUILDING'S INSULATION ENVELOPE (SUCH AS ABOVE THE ATTIC INSULATION). TYPICAL INSULATION THICKNESS REQUIRED TO MEET THESE REQUIREMENTS: 1. FIBERGLASS DUCT WRAP: R-6, R-12. 2. FIBERGLASS DUCT LINER: R-6, R-12.
C.	CONTRACTOR SHALL VERIFY THE R-VALUES OF THE ACTUAL INSULATION USED WITH THE MANUFACTURER. R-VALUES SHALL BE INSTALLED VALUES.
D.	WHERE DUCTS USED FOR COOLING ARE EXTERNALLY INSULATED, THE INSULATION SHALL BE COVERED WITH A VAPOR RETARDER HAVING A MAXIMUM PERMEANCE OF 0.05 PERM OR ALUMINUM FOIL HAVING A MINIMUM THICKNESS OF 2 MILS. INSULATION HAVING A PERMEANCE OF 0.05 PERMS OR LESS SHALL NOT BE REQUIRED TO BE COVERED. ALL JOINTS AND SEAMS SHALL BE SEALED TO MAINTAIN THE CONTINUITY OF THE VAPOR RETARDER.
E.	ALL DUCT JOINTS, SEAMS, AND CONNECTIONS SHALL BE FASTENED AND SEALED WITH WELDS, GASKETS, ADHESIVES, MASTIC-PLUS-EMBEDDED-FABRIC SYSTEMS, OR TAPES. TAPES AND MASTICS SHALL BE LISTED AND LABELED PER UL181A OR UL181B. DUCT TAPE IS NOT PERMITTED AS A SEALANT ON ANY METAL DUCTS. DUCT CONNECTIONS TO FLANGES OR EQUIPMENT SHALL BE SEALED AND MECHANICALLY FASTENED.
F.	DOMESTIC HOT WATER PIPING SYSTEMS SHALL BE INSULATED WITH 1" INSULATION HAVING A CONDUCTIVITY NOT EXCEEDING 0.27 BTU-INCH/HOUR-FT2-F.
G.	DOMESTIC WATER HEATERS WHICH ARE NOT PROVIDED WITH INTEGRAL HEAT TRAPS AND SERVE NONCIRCULATING SYSTEMS SHALL BE PROVIDED WITH HEAT TRAPS ON THE SUPPLY AND DISCHARGE PIPING AT THE WATER HEATER.
H.	DOMESTIC HOT WATER SYSTEMS WITH RECIRCULATION PUMPS OR ELECTRIC HEAT TRACE SHALL BE CONTROLLED WITH 7-DAY TIME CLOCKS.
I.	AN OPERATING AND MAINTENANCE MANUAL SHALL BE PROVIDED PRIOR TO ISSUANCE OF A CERTIFICATE OF OCCUPANCY. THE O&M MANUAL SHALL CONTAIN THE FOLLOWING INFORMATION AS A MINIMUM: 1. EQUIPMENT CAPACITY (INPUT & OUTPUT). 2. EQUIPMENT OPERATING AND MAINTENANCE INSTRUCTIONS. 3. CONTROL SYSTEM MAINTENANCE AND CALIBRATION INFORMATION, INCLUDING WIRING DIAGRAMS, SCHEMATICS, AND CONTROL SEQUENCES. 4. CONTROL SYSTEM SETPOINTS SHALL BE SHOWN ON CONTROL DRAWINGS, AT CONTROL DEVICES, OR IN PROGRAMMING COMMENT ON DDC SYSTEMS. 5. A COMPLETE WRITTEN NARRATIVE ON HOW EACH MECHANICAL SYSTEM IS INTENDED TO OPERATE.

STAMP:

DPW 21535 - IDJC
LAUNDRY &
KITCHEN
REMODEL - JCCN

IDAHO DPW - IDJC

CONSULTANT:

DESCRIPTION	
MRK	DATE

JOB NO.: 22003.01
DATE: 08/12/22
DRAWN BY: AH
CHECKED BY: BC

PHASE: 100% DESIGN
DEVELOPMENT

MECHANICAL
COVER SHEET

SHEET NO.

M0.0



**MUSGROVE
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234 S. Whisperwood Way
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www.musgrovepa.com
PROJECT NO. 22-059

LOMBARD
CONRAD
ARCHITECTS

ARCHITECTURE | PLANNING
INTERIOR DESIGN

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STAMP:

**DPW 21535 - IDJC
LAUNDRY &
KITCHEN
REMODEL - JCCN**

IDAHO DPW - IDJC

CONSULTANT:

[illegible]

JOB NO.: 22003.01
DATE: 08/12/22
DRAWN BY: AH
CHECKED BY: BC

PHASE: **100% DESIGN DEVELOPMENT**

MECHANICAL ENERGY COMPLIANCE

SHEET NO.

M0.1

A

B

C

D

1

2

3

4

5

6



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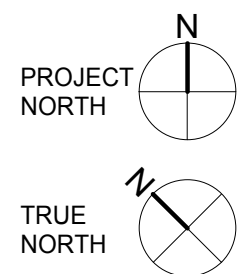
KEYED NOTES:

⑧ SYMBOL USED FOR CALLOUT

1. REMOVE ALL EXISTING DIFFUSERS, RETURN AND EXHAUST GRILLES AS SHOWN.
2. REMOVE EXISTING SUPPLY AND EXHAUST GRILLE IN THIS SPACE. REMOVE DUCTING BACK TO MAIN LINES AS SHOWN. SEE NEW PLAN.
3. REMOVE EXISTING DRYER DUCT UP THROUGH ROOF. PATCH ROOF TO MATCH EXISTING.
4. EXISTING GRILLE AND DUCTING TO REMAIN AS-IS.
5. EXISTING DIFFUSER AND RETURN GRILLE TO REMAIN. REMOVE GRILLE FOR PLACEMENT OF NEW CEILING. CLEAN, REPAIR AND PAINT GRILLE TO MATCH NEW DIFFUSERS. SEE NEW WORK PLAN.
6. REMOVE AND RELOCATE EXISTING GRILLE TO NEW LOCATION INSIDE NEW LAUNDRY ROOM. REMOVE EXISTING FLEXIBLE DUCTWORK FROM GRILLE BACK TO BRANCH DUCT.
7. REMOVE PORTION OF EXISTING DUCTWORK AS SHOWN. CAP EXISTING DUCT AT LOCATION OF REMOVED TRANSITION.
8. COMPLETELY REMOVE EXISTING COMBUSTION AIR DUCT FROM ROOF INTO SPACE. PATCH ROOF TO MATCH EXISTING AND MAINTAIN ROOF WARRANTY.
9. CAP BACK AT MAIN. CAP TO BE AIR TIGHT.

1 DEMO HVAC PLAN

1/8" = 1'-0"



IDAHO DPW - IDJC

CONSULTANT:

MRK DATE DESCRIPTION

JOB NO.: 22003.01
DATE: 08/12/22
DRAWN BY: AH
CHECKED BY: BC

PHASE: 100% DESIGN
DEVELOPMENT

HVAC DEMO
PLAN

SHEET NO.

M1.0



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645 West 25th Street
Idaho Falls, ID 83402
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www.musgrovepa.com
PROJECT NO. 22-059

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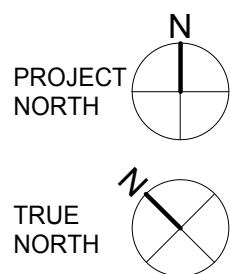
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KEYED NOTES:

1. PLACE NEW DIFFUSERS AND RETURN GRILLES IN SAME LOCATION AS EXISTING GRILLES. CONNECT TO EXISTING DUCTWORK.
2. ROUTE 14" DRYER DUCTS UP THROUGH ROOF AND TERMATE PER MANUFACTURER'S RECOMMENDATION.
3. EXISTING GRILLES ABOVE FREEZER AND COOLER UNIT ARE TO REMAIN AS-IS.
4. RELOCATE EXISTING GRILLES SLIGHTLY TO ALIGN WITH NEW CEILING GRID.
5. RELOCATE EXISTING GRILLE THAT WAS REMOVED TO THIS LOCATION. PROVIDE NEW FLEXIBLE DUCTWORK FROM EXISTING BRANCH DUCT TO NEW LOCATION. REBALANCE GRILLE TO NEW CFM.
6. RELOCATE EXISTING GRILLES SLIGHTLY TO ALIGN WITH NEW CEILING GRID. REBALANCE TO NEW CFM.
7. DUCT UP TO MAU-1 ON ROOF. SEE HVAC ROOF PLAN FOR PLACEMENT OF UNIT. TRANSITION TO CONNECTION OF UNIT AS NEEDED. PROVIDE WITH FLEXIBLE CONNECTION AT UNIT.
8. DUCT MOUNTED THERMOSTAT FOR CONTROL OF GAS MODULATION OF MAU ON ROOF.
9. WALL MOUNTED THERMOSTAT FOR ENABLE/DISABLE CONTROL OF GAS HEAT SECTION OF MAU ON ROOF.
10. WALL MOUNTED PRESSURE SENSOR FOR ENABLE/DISABLE CONTROL OF FAN SECTION OF MAU ON ROOF.

1 NEW HVAC PLAN

1/8" = 1'-0"



DESCRIPTION

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HVAC NEW PLAN

SHEET NO.

M1.1

1

2

3

4

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6

A

B

C

D

1

2

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4

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KEYED NOTES:

① SYMBOL USED FOR CALLOUT

1. PLACE NEW MAU ON ROOF FOR MAKE-UP TO DRYERS. COORDINATE
PLACEMENT WITH DRYER VENTS, PLUMBING VENTS AND EXISTING
ROOFTOP EQUIPMENT. SEE MOUTNING DETAIL.

2. 14"Ø DRYER DUCTS UP THROUGH ROOF FROM DRYERS BELOW. SEE
HVAC FLOOR PLAN FOR DRYER PLACEMENT. TERMINATE PER
MANUFACTURER'S RECOMMENDATIONS.

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LAUNDRY &
KITCHEN
REMODEL - JCCN

IDAHO DPW - IDJC

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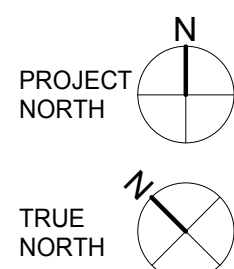
PHASE: 100% DESIGN
DEVELOPMENT

HVAC ROOF PLAN

SHEET NO.


M2.0

1 NEW HVAC ROOF PLAN
3/64" = 1'-0"




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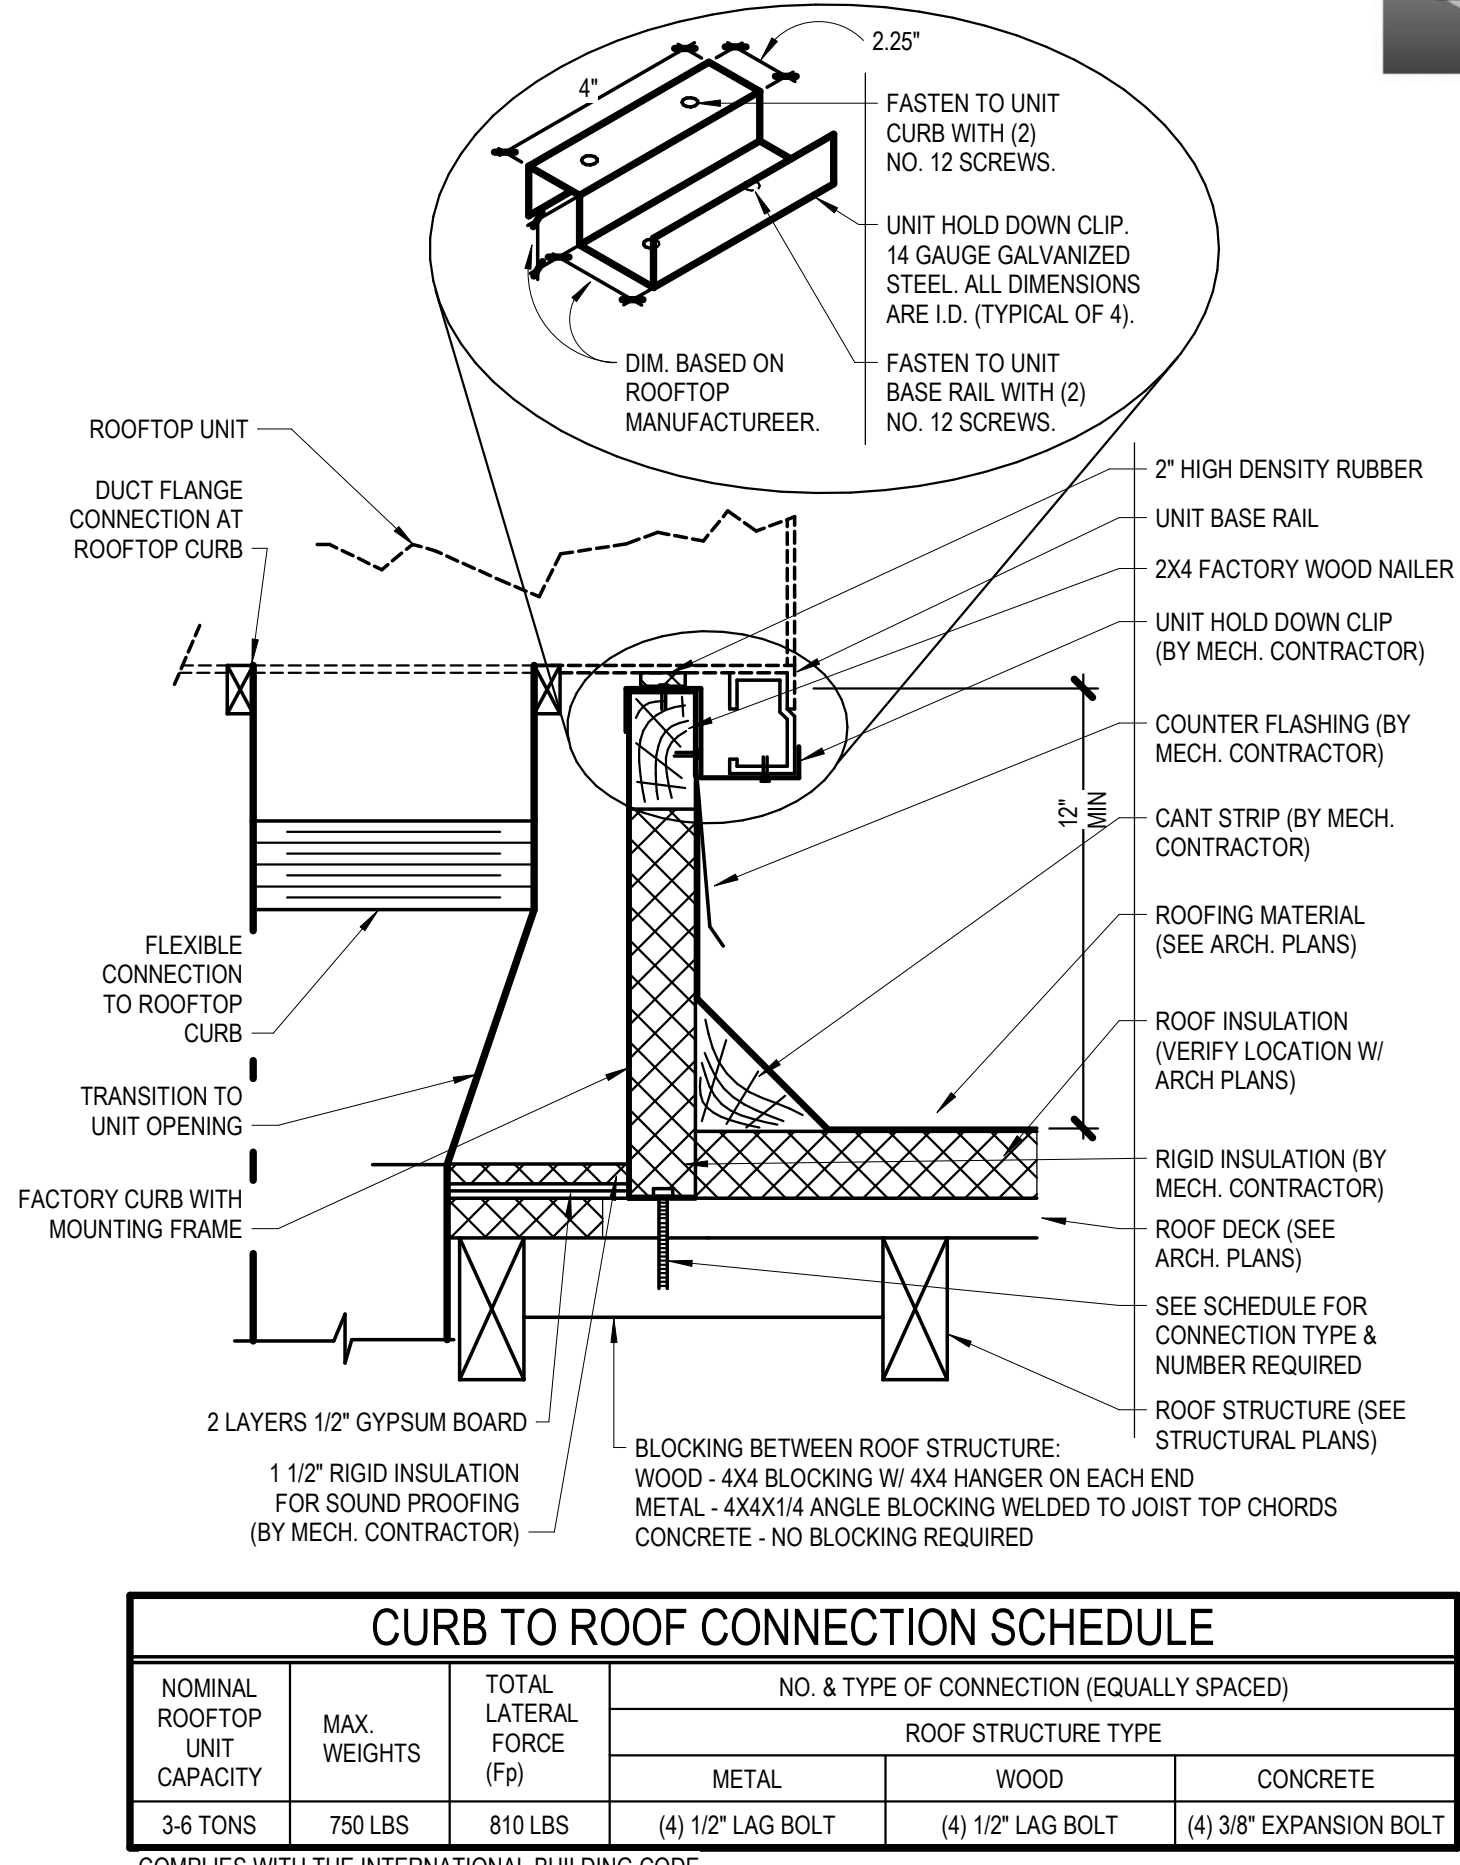
- FOR TAKE-OFFS LARGER THAN 12" DIAMETER, USE A FACTORY MANUFACTURED DAMPER. LOUVERS & DAMPERS, INC. MODEL CD-600 WITH A LOCKING HAND QUADRANT OR EQUAL.
- ROD CONTINUOUS ON 2" W.G. CLASS AND ON ALL DAMPERS OVER 12" DIAMETER.
- BLADE 22 GAGE MIN., BUT NOT LESS THAN TWO GAGES MORE THAN THE DUCT GAGE.
- PROVIDE REMOTE CEILING OPERATOR WHERE DAMPER IS INACCESSIBLE.
- FOR DUCTS OVER 12" HIGH USE MULTIPLE BLADE DAMPERS (SEE FIG. C).
- ALTERNATE MANUFACTURERS INCLUDE: AMERICAN WARMING, SAFE-AIR/DOWCO, J&J, LOUVERS & DAMPERS, RUSKIN, NAILOR, ARROW UNITED, POTTORFF, & CESCO.

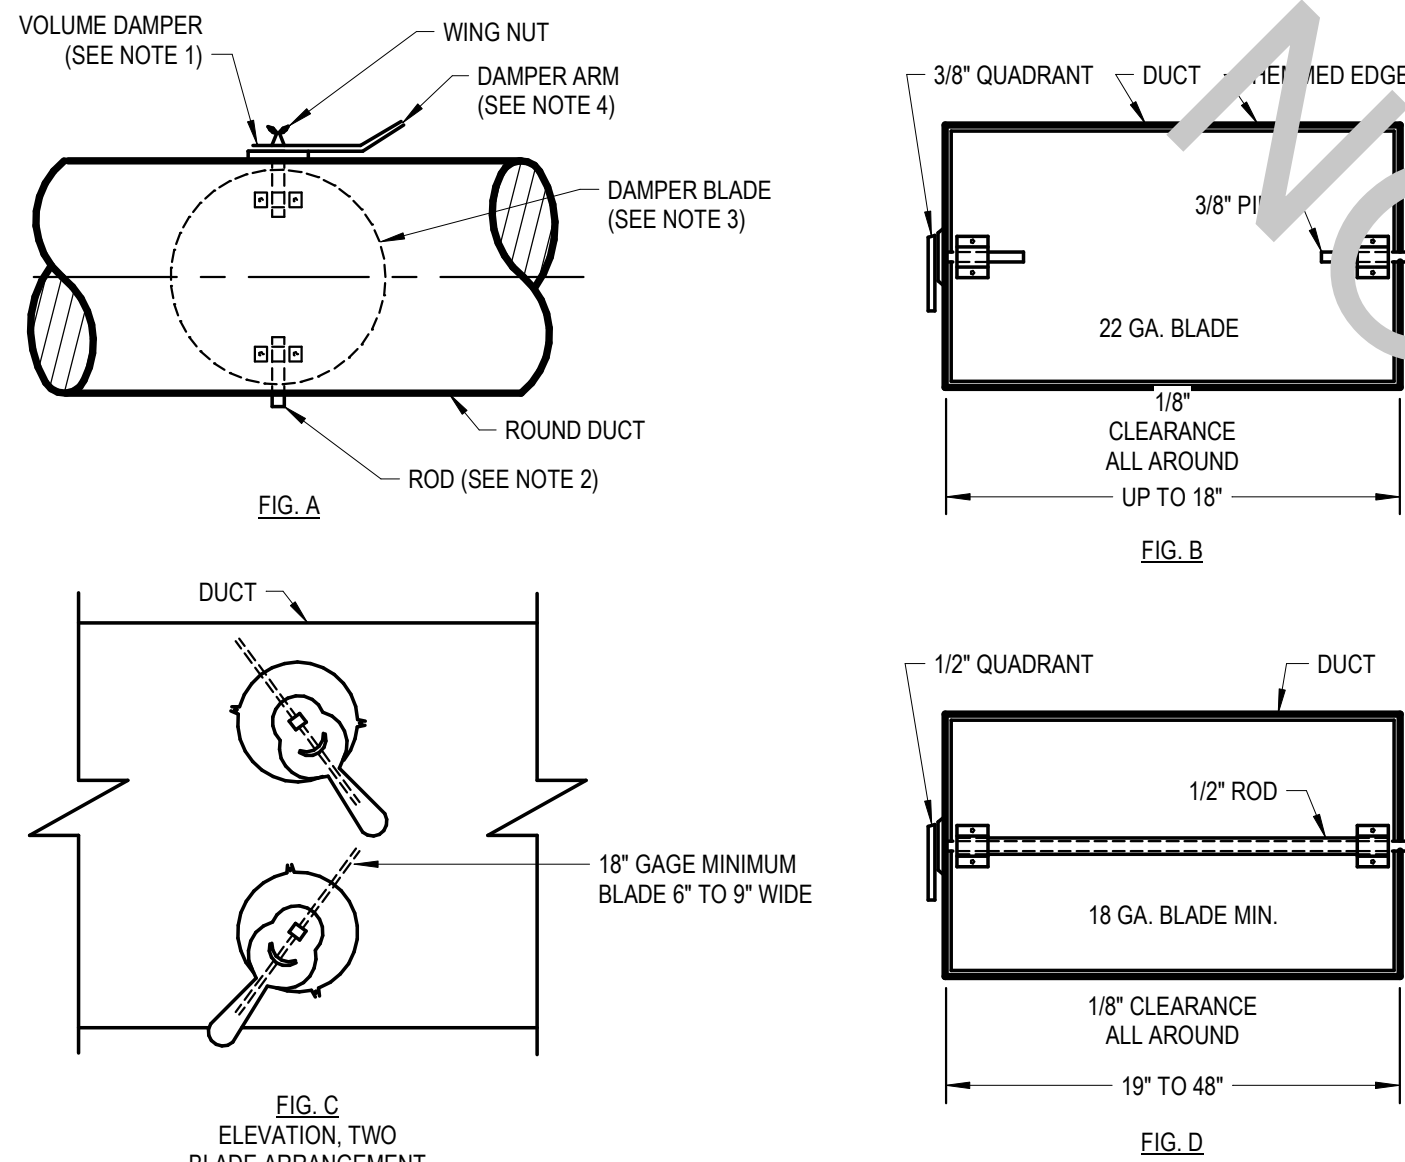


① BALANCE DAMPER DETAIL
NTS

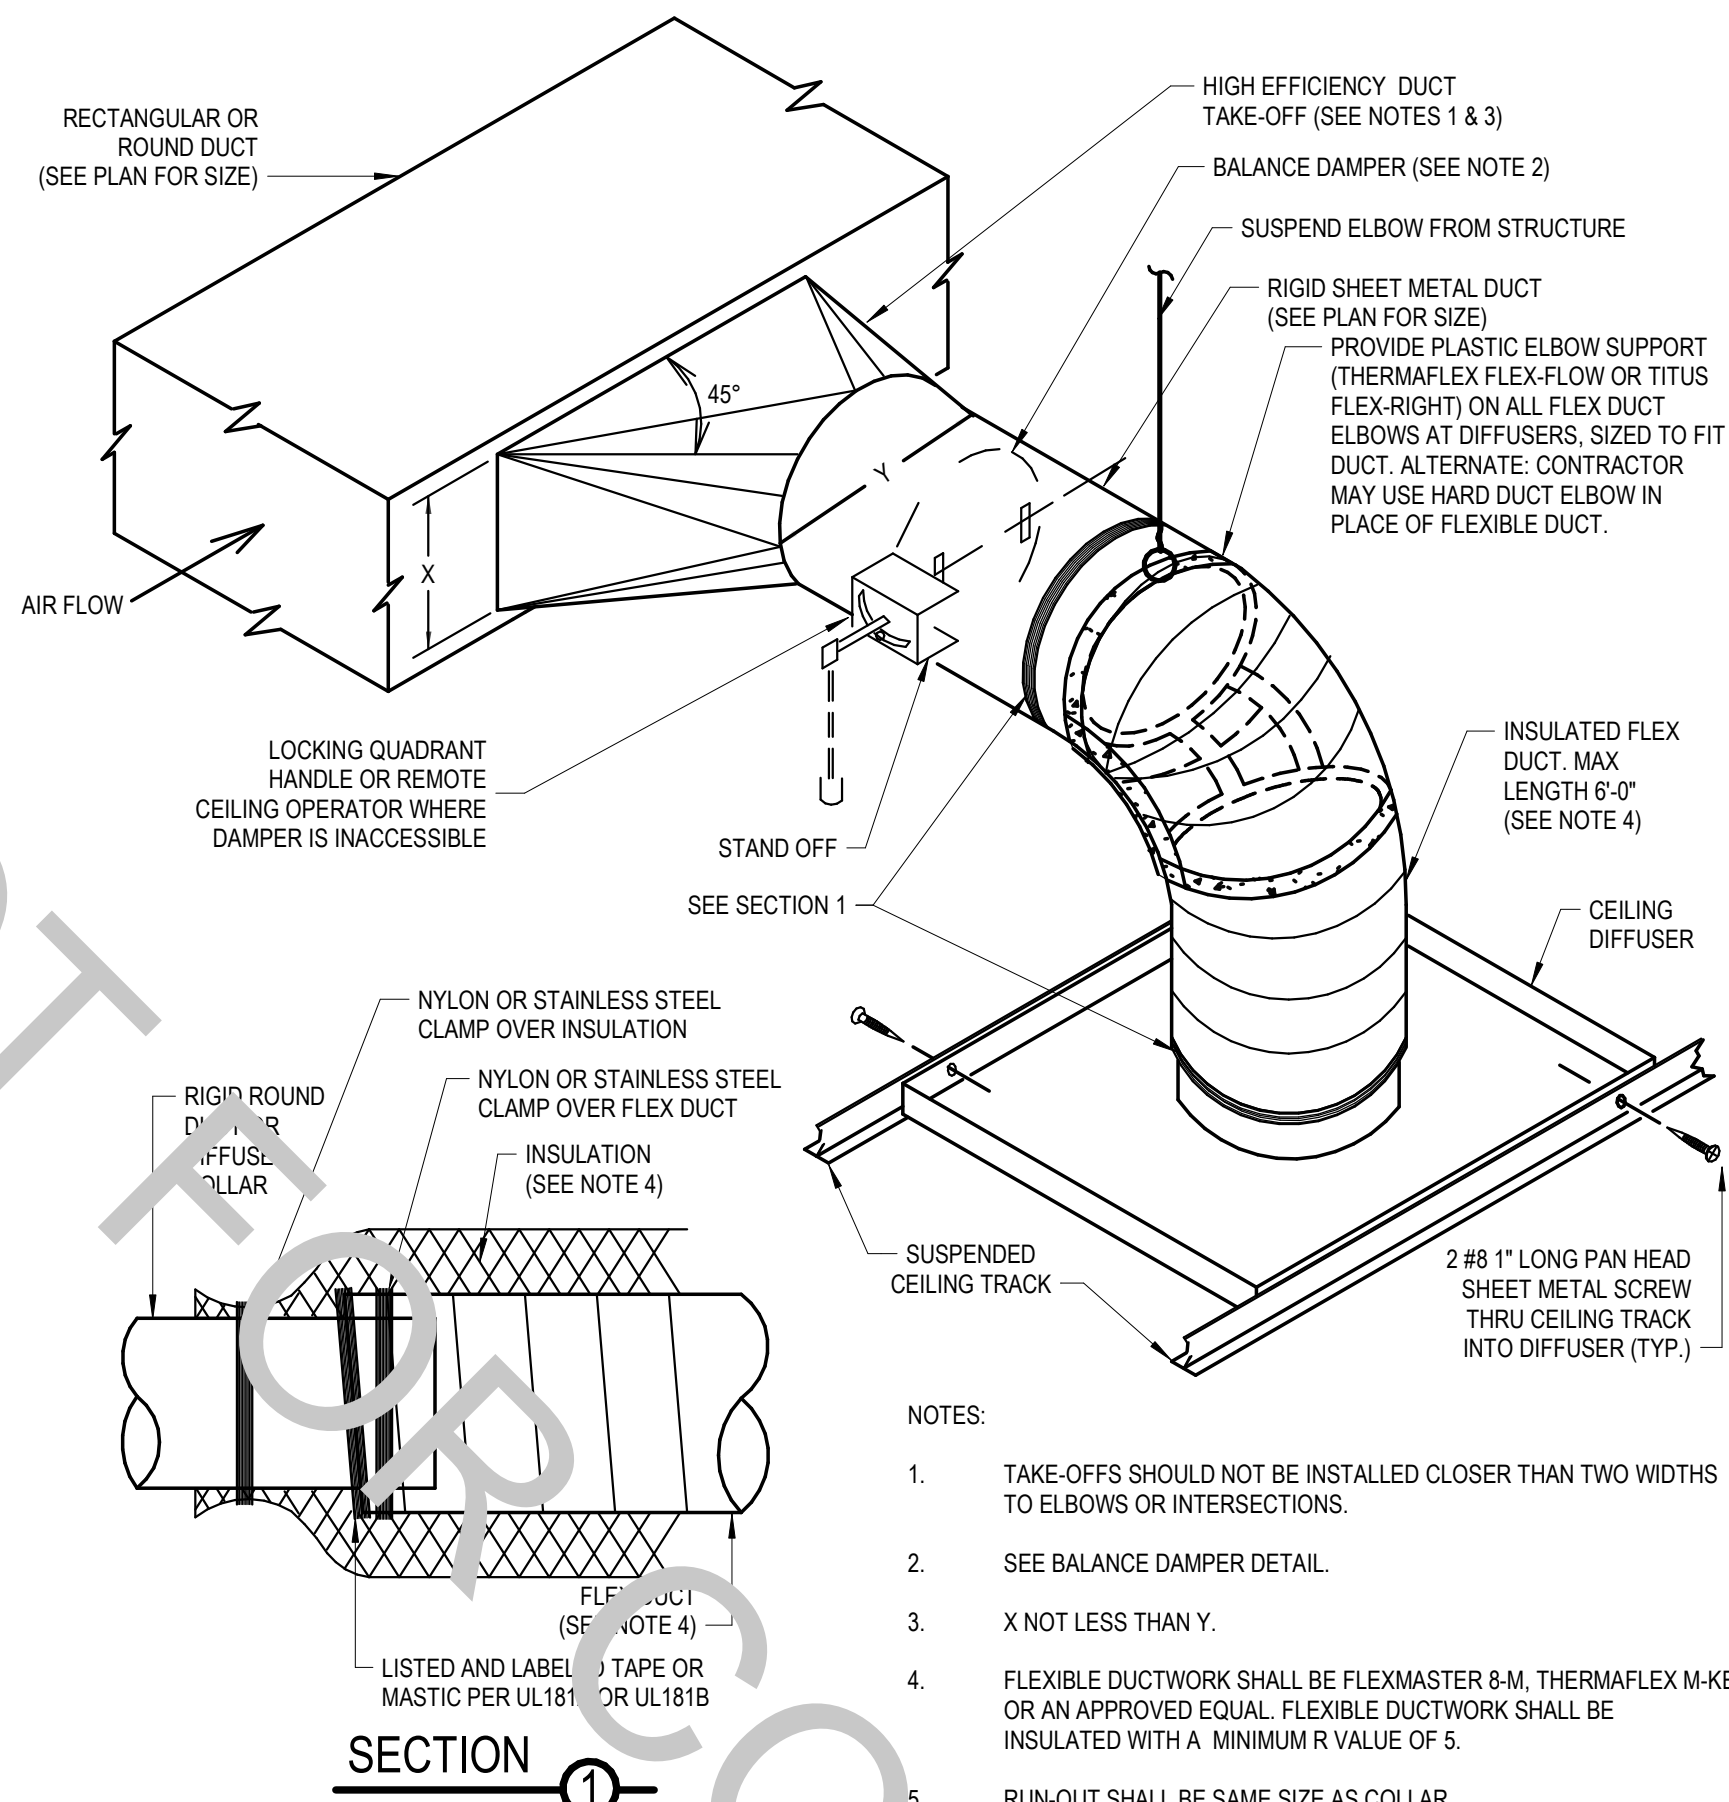


② DUCT TAKEOFF DETAIL - HIGH EFFICIENT
NTS



③ ROOFTOP UNIT MOUNTING DETAIL
NTS

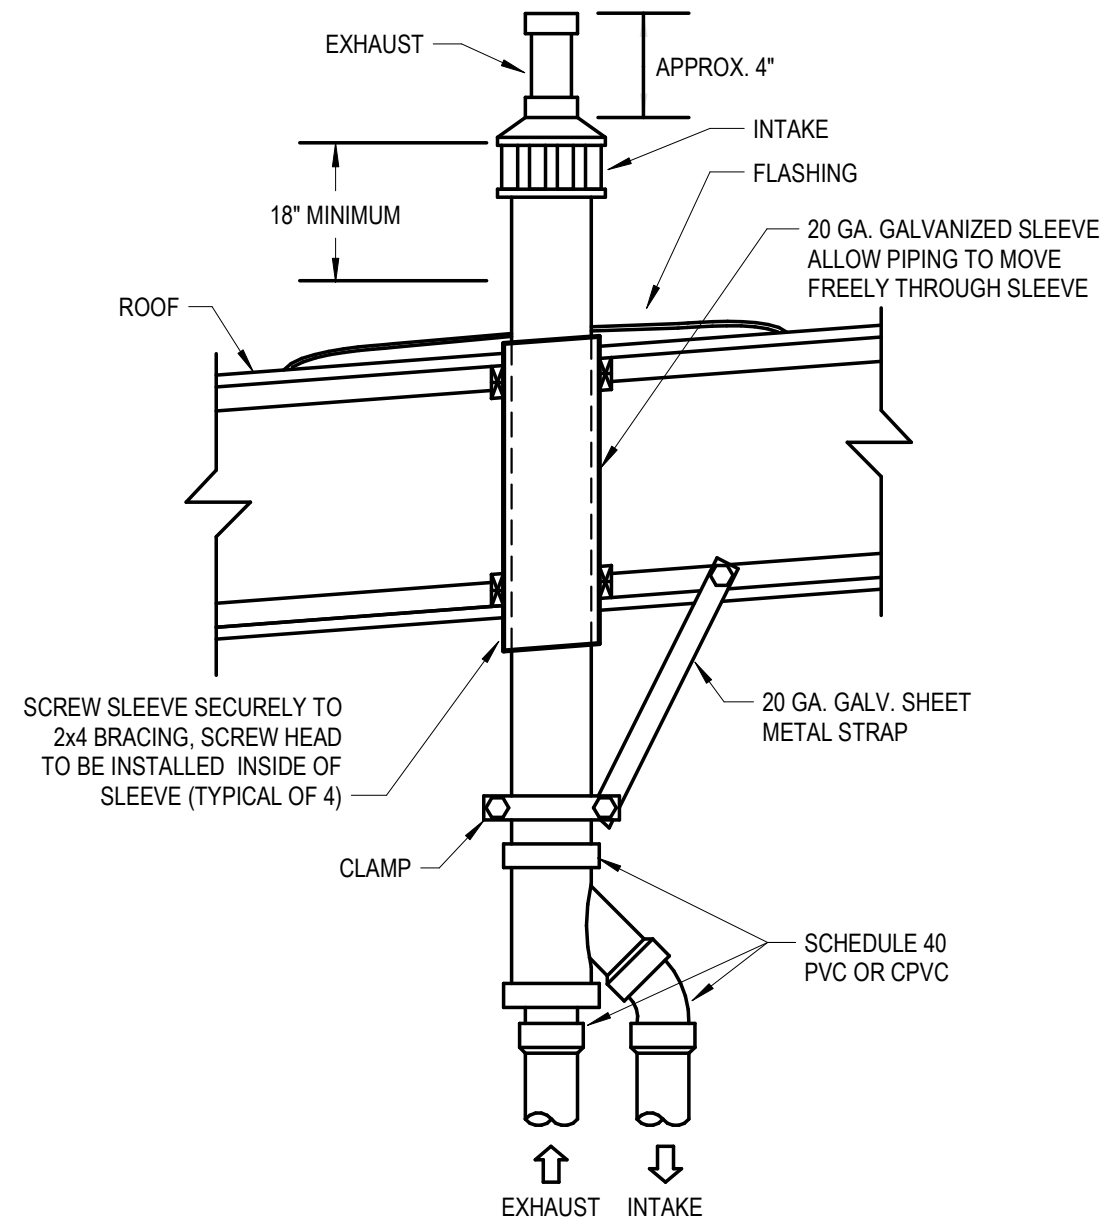


④ GAS VENT DETAIL (CONCENTRIC - 90%)
NTS

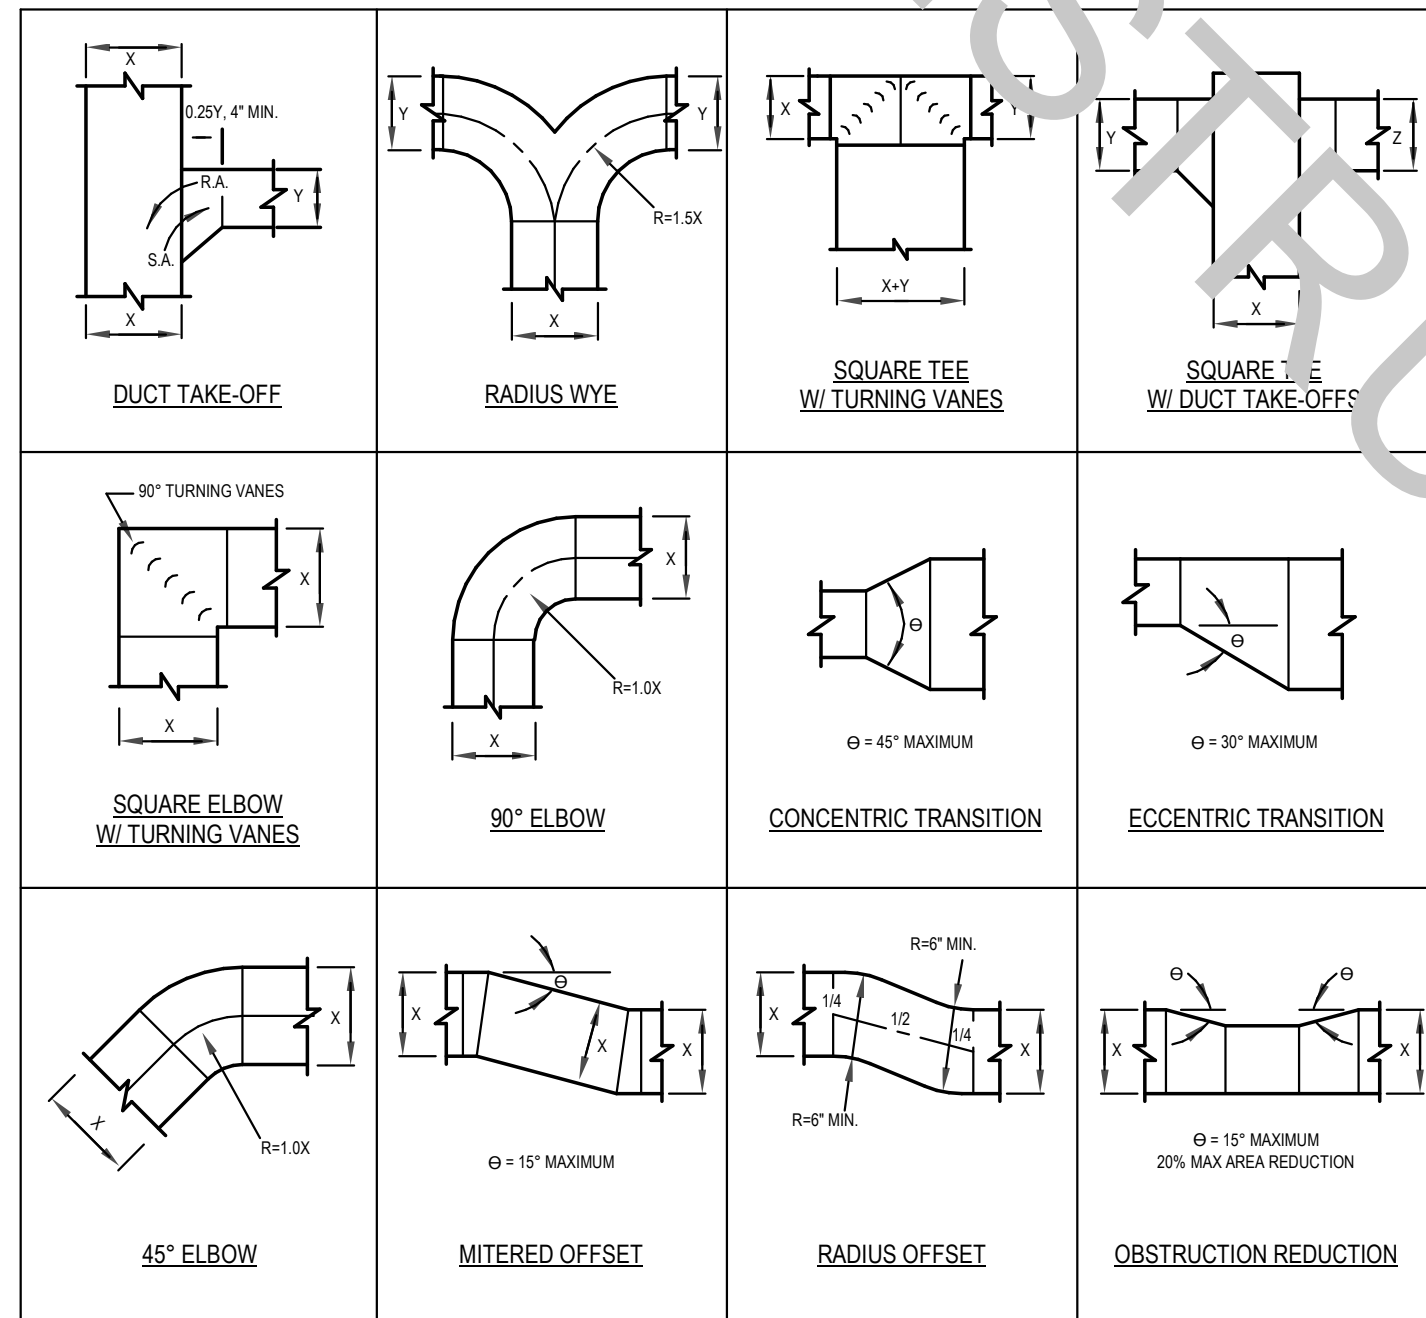

NOTE:
ALL DUCTWORK TRANSITIONS SHALL BE CONSTRUCTED AND INSTALLED TO SMACNA, SPECIFICATIONS AND THE ABOVE NOTED STANDARDS. ANY DEVIATIONS SHALL BE COORDINATED WITH THE ENGINEER.

⑤ RECTANGULAR DUCT FITTING DETAILS
NTS

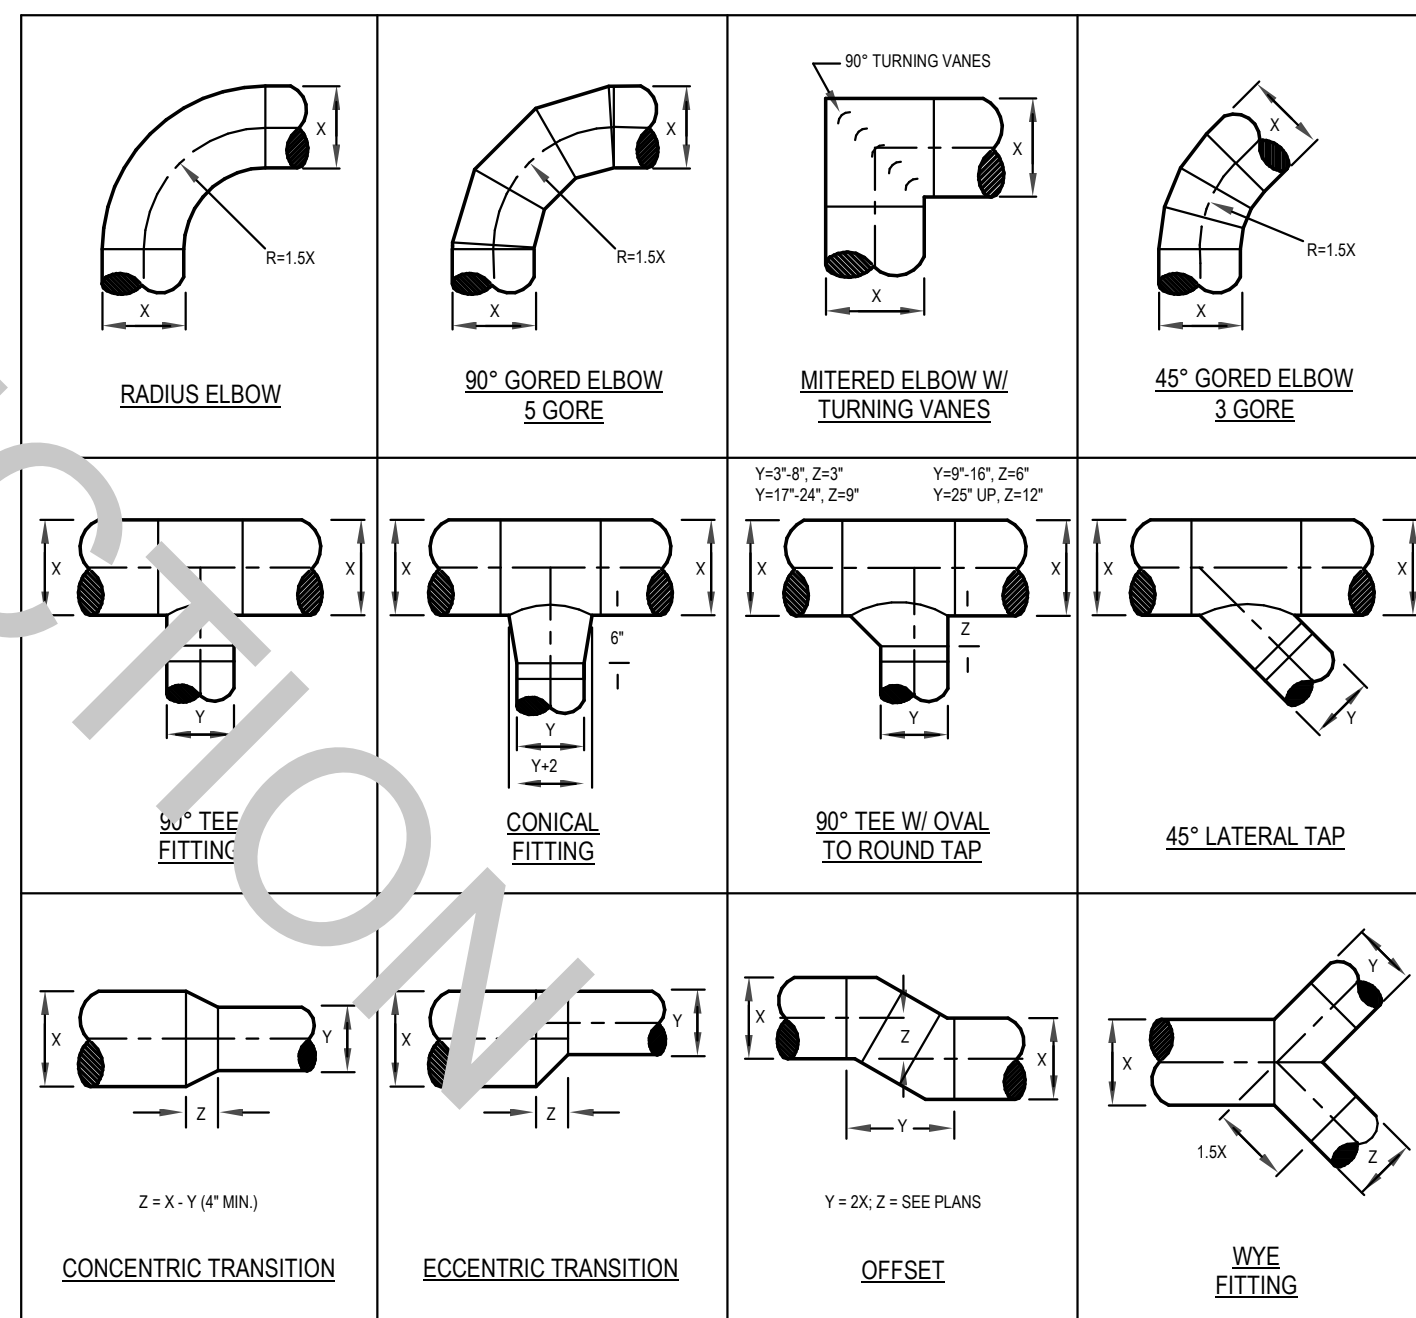

NOTE:
ALL DUCTWORK TRANSITIONS SHALL BE CONSTRUCTED AND INSTALLED TO SMACNA, SPECIFICATIONS, AND THE ABOVE NOTED STANDARDS. ANY DEVIATIONS SHALL BE COORDINATED WITH THE ENGINEER.

⑥ ROUND DUCT FITTING DETAILS
NTS

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PHASE: 100% DESIGN
DEVELOPMENT

HVAC DETAILS

SHEET NO.

M3.0



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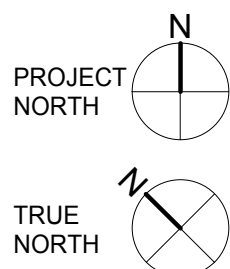
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KEYED NOTES:

⑤ SYMBOL USED FOR CALLOUT

1. CUT FLOOR AND REMOVE EXISTING HUB DRAIN. SEE NEW PLAN FOR NEW WORK.
2. REMOVE EXISTING FLOOR DRAIN.
3. REMOVE EXISTING WASTE CONNECTION TO WALL BOX BEING REMOVED. CAP WASTE BELOW SLAB.
4. REMOVE PORTION OF EXISTING WASTE PIPING THAT IS FAILING AND REPLACE WITH NEW IN THIS AREA.

1 DEMO PLUMBING FOUNDATION PLAN
1/8" = 1'-0"



DPW 21535 - IDJC
LAUNDRY &
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REMODEL - JCCN

IDAHO DPW - IDJC

CONSULTANT:

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PHASE: 100% DESIGN
DEVELOPMENT

PLUMBING DEMO
FOUNDATION

SHEET NO.

P1.0

STAMP:

**DPW 21535 - IDJC
LAUNDRY &
KITCHEN
REMODEL - JCCN**

IDAHO DPW - IDJC

CONSULTANT

MRK	DATE	DESCRIPTION



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DATE: 08/12/22
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CHECKED BY: BC

PHASE: 100% DESIGN DEVELOPMENT

PLUMBING NEW FOUNDATION

SHEET NO. _____

P1.1

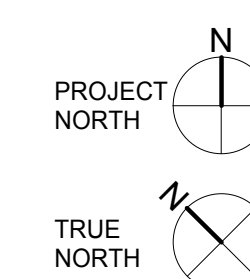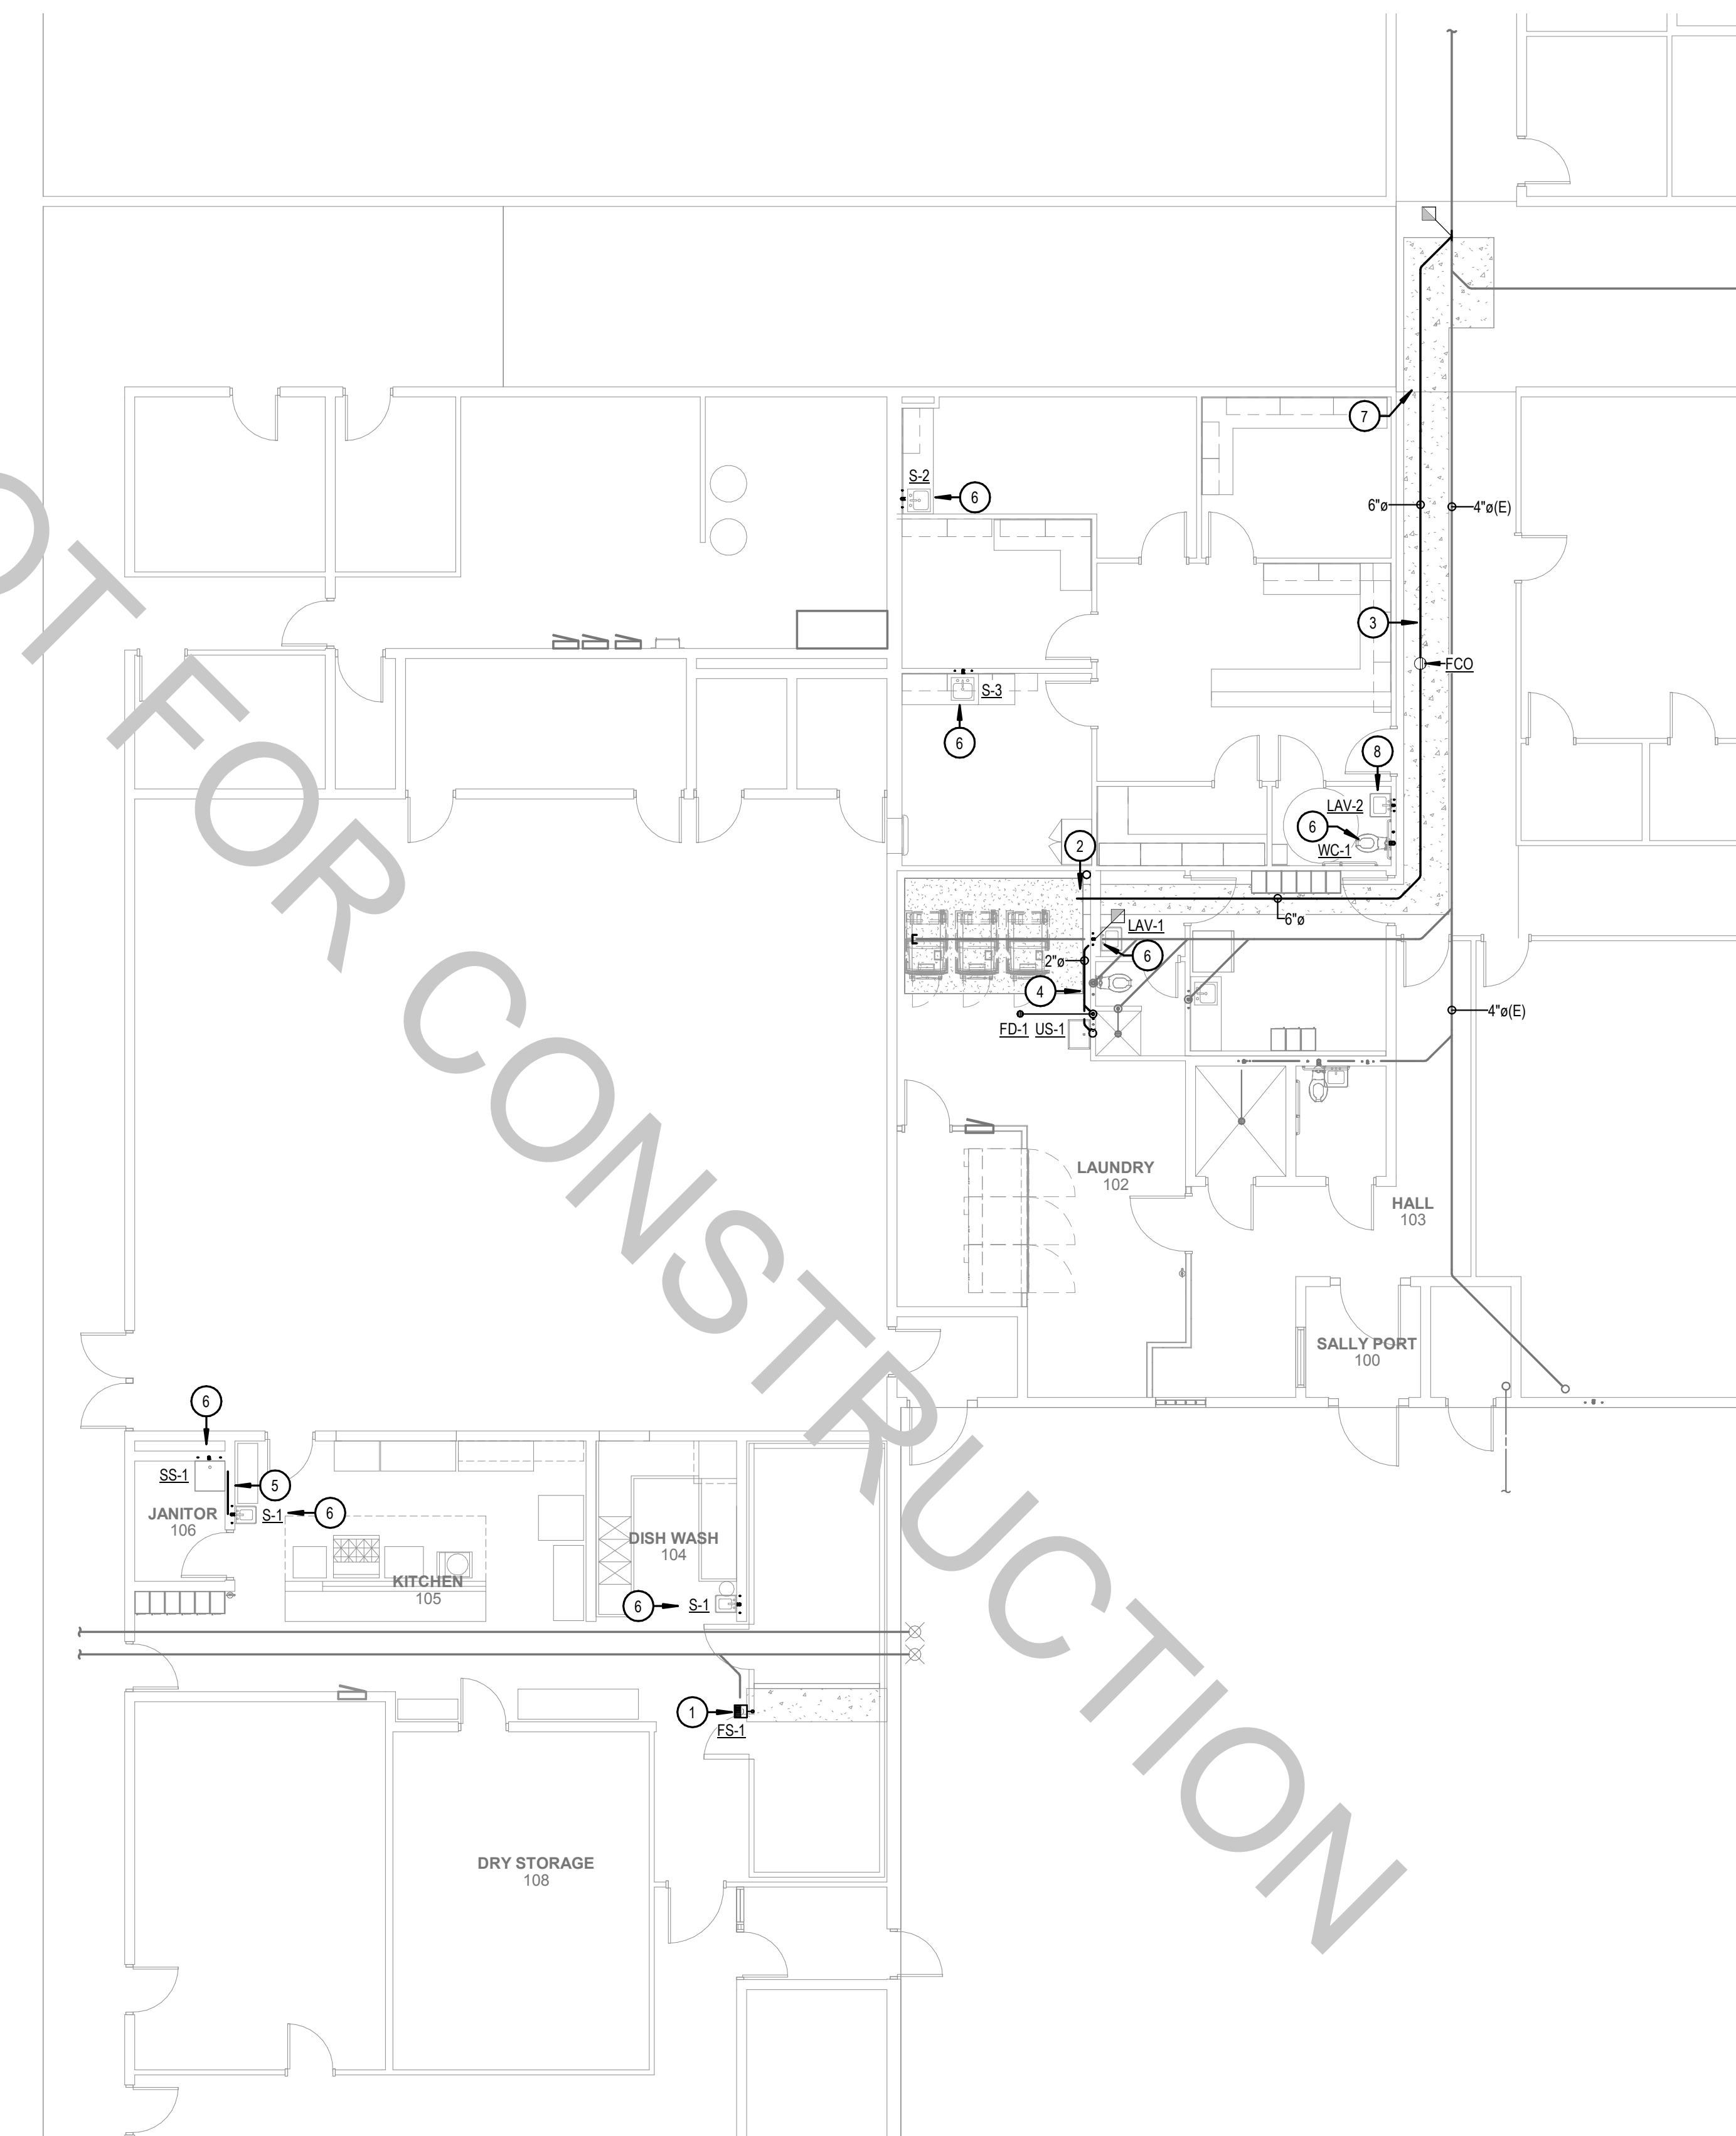

1 NEW PLUMBING FOUNDATION PLAN
1/8" = 1'-0"



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KEYED NOTES:

1. REMOVE EXISTING 100 GALLON 80% GAS WATER HEATERS. REMOVE EXISTING COMBUSTION AIR DUCTING AND EXISTING TYPE B VENT PENETRATIONS THROUGH ROOF AND PATCH ROOF.
2. REMOVE WALL BOX AND ASSOICATED WATER LINES IN CEILING SPACE. REMOVE BACK TO MAIN AND CAP AT NEAREST FITTING.
3. REMOVE EXISTING VENT PIPING IN WALL AND CEILING SPACE. REMOVE EXISTING VTR IN ROOF. LEAVE EXISTING OPENING FOR NEW VTR.
4. PIECE OF KITCHEN EQUIPMENT TO BE REMOVED. REMOVE EXISTING GAS CONNECTION BACK TO WALL.
5. DISCONNECT EXISTING PLUMBING AND REMOVE EXISTING FIXTURE. NEW FIXTURE TO BE PLACED IN SAME LOCATION AS EXISTING.
6. DISCONNECT EXISTING PLUMBING AND REMOVE EXISTING FIXTURE. NEW FLOOR MOUNTED FIXTURE TO BE LOCATED IN SAME LOCATION.
7. REMOVE EXISTING LAV. EXISTING PLUMBING CONNECTIONS TO REMAIN FOR RECONNECTION. CONTRACTOR TO REMOVE LAV WHILE LEAVING SUPPORT IN WALL. NEW LAV TO BE PLACED ON EXISTING SUPPORT.
8. REMOVE EXISTING PLUMBING FIXTURE. CAP EXISTING WATER AND WASTE PIPING AT WALL. FIXTURE NOT TO BE REPLACED.
9. REMOVE EXISTING WATER SOFTENER AND REPLACE WITH NEW. SEE NEW WORK PLAN.

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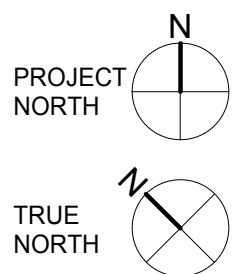
PHASE: 100% DESIGN
DEVELOPMENT

PLUMBING DEMO
1ST FLOOR

SHEET NO.

P2.0

1 DEMO PLUMBING 1ST FLOOR PLAN
1/8" = 1'-0"





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STAMP:

KEYED NOTES:

1. CONNECT NEW 1/2" CW AND 1/2" HW LINES TO EXISTING CW AND HW IN WALL SERVING 3-COMPARTMENT SINK. ROUTE EACH NEW LINE THROUGH RPBP-1 BEFORE CONNECTING TO NEW GAS STEAM KETTLE. DRAIN RPBP FIXTURES TO FLOOR SINK BELOW 3-COMPARTMENT SINK.
2. RELOCATE EXISTING OVEN TO NEW LOCATION. SPLIT EXISTING GAS CONNECTION FROM EXISTING EQUIPMENT. ROUTE ONE LINE TO RELOCATED OVEN AND ROUTE OTHER LINE TO NEW GRILLIE LOCATION AND CONNECT.
3. INSTALL NEW GAS STEAM KETTLE AT THIS LOCATION. CONNECT TO EXISTING GAS SUPPLY AT THIS LOCATION. CONNECT NEW WATER LINES. SEE KEYED NOTE 1. ROUTE DRAIN PIPE FROM DRAIN DRAWER OF STEAM KETTLE TO EXISTING FLOOR SINK AT THIS LOCATION.
4. INSTALL NEW PLUMBING FIXTURE IN LOCATION OF EXISTING. CONNECT TO EXISTING CONNECTIONS AT EACH LOCATION.
5. INSTALL NEW WATER SOFTENER IN LOCATION OF EXISTING UNIT.
6. RE-ROUTE EXISTING FIRE SPINKLER PIPING INTO HALLWAY AND PROVIDE ACCESS IN CEILING FOR DRAIN. EXISTING DRAIN LOCATED OVER FREEZER TO BE REMOVED AND RELOCATED.
7. INSTALL NEW DEDICATED WATER HEATER FOR LAUNDRY. INSTALL RPBP-1 ON COLD WATER LINE GOING TO WATER HEATER. ROUTE NEW 2" DEDICATED HW AND 3/4" HWR LINES TO WASHER LOCATION. SEE WATER HEATER PIPING DETAIL FOR MORE INFORMATION. ROUTE NEW VENT AND COMBUSTION AIR PIPING OUT ROOF AND TERMINATE WITH CONCENTRIC VENT KIT. ROUTE DRAIN TO FLOOR SINK LOCATED BETWEEN BOTH WH-2.
8. PLACE NEW WATER HEATERS IN LOCATION OF EXISTING REMOVED HEATERS. CUT NEW PENETRATIONS FOR NEW CONCENTRIC VENTS FOR WATER HEATERS. REUSE EXISTING RECIRCULATION PUMP AND EXPANSION TANK. SEE WATER HEATER PIPING DETAIL. RECONNECT TO EXISTING GAS SERVICE.
9. INSTALL NEW PLUMBING FIXTURE IN LOCATION. CONNECT TO EXISTING WATER IN WALL. SAW CUT FLOOR TO CONNECT NEW WATER PIPING UNDERGROUND TO EXISING WASTE PIPING IN AREA. ROUTE NEW VENT PIPING UP WALL, ENCASE AND CONNECT TO EXISTING VENT SYSTEM IN AREA.
10. CONNECT NEW 1/2" CW AND 1/2" HW LINES TO EXISTING LINES IN WALL THAT SERVICE EXISTING SHOWER FOR WATER SUPPLY TO US-1. EXISTING LINES IN WALL TO SERVE SHOWER AND UTILITY SINK.
11. ROUTE VENT PIPING DOWN CORNER OF ROOM TO TRAP OF WASTE PIPING CONNECTED TO FLOOR TROUGH DRAIN.
12. INSTALL NEW 3" VENT FOR NEW FLOOR TROUGH DRAIN. ROUTE 3" VENT PIPING UP THROUGH ROOF IN SAME LOCATION AS EXISTING, REMOVED, VTR.
13. ROUTE 3/4" CONDENSATE LINE FROM CONDENER IN FREEZER AND COOLER UNITS TO FLOOR SINK AS SHOWN. HEAT TAPE AND INSULATE FREEZER CONDENSATE LOCATED INSIDE FREEZER.
14. SEE COMMERCIAL CLOTHES WASHER PIPING DETAIL FOR CONNECTION INFORMATION TO WASHERS.
15. CONNECT GAS TO DRYER. PROVIDE WITH SHUT-OFF VALVE AND FLEXIBLE CONNECTION AT UNIT. SEE DETAIL.
16. CONNECT GAS TO NEW WATER HEATER. PROVIDE WITH SHUT-OFF VALVE AND FLEXIBLE CONNECTION. SEE WATER HEATER PIPING DETAIL AND GAS CONNECTION DETAIL.
17. CONNECT NEW FIXTURE TO EXISTING PIPING. PLACE NEW LAV ON EXISTING SUPPORTS FROM EXISTING LAV. CONTRACTOR TO FIELD VERIFY EXISTING MODEL AND MOUNTING PRIOR TO ORDERING NEW FIXTURE TO ENSURE NEW FIXTURE WILL FIT ON EXISTING SUPPORT.
18. GAS PIPE DOWN FROM ROOF. SEE PLUMBING ROOF PLAN FOR CONTINUATION.
19. ROUTE DRAIN FROM RPBP-1 TO FLOOR SINK BETWEEN BOTH WH-2.
20. DRAIN RPBP-1 TO FLOOR TROUGH BELOW.

CONSULTANT:

DESCRIPTION

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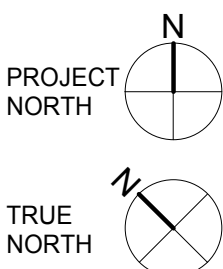
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DEVELOPMENT

PLUMBING NEW
1ST FLOOR

SHEET NO.

P2.1

1 NEW PLUMBING 1ST FLOOR PLAN
1/8" = 1'-0"



SYMBOL USED FOR CALLOUT

1. ROUTE NEW GAS PIPING FROM EXISTING GAS METER TO NEW DRYER LOCATIONS. CONNECT TO NEW MAU, NEW DRYERS AND NEW WATER HEATER. SEE ROOF MOUNTED PIPING DETAIL.
2. ROUTE DOWN THROUGH ROOF TO CONNECT TO NEW GAS DRYERS. SEE PLUMBING FLOOR PLAN FOR CONTINUATION.
3. ROUTE EXPOSED DOWN EXTERIOR OF BUILDING AND CONNECT TO EXISTING GAS METER. CONTRACTOR TO COORDINATE WITH INTERMOUNTAIN GAS FOR NEW ADDITIONAL GAS LOAD ADDED TO METER.
4. ROUTE DOWN THROUGH ROOF TO CONNECT TO NEW WATER HEATER.
5. COORDINATE GAS ROUTING LOCATION WITH SKYLIGHTS.
6. SEE ROOFTOP EQUIPMENT GAS CONNECTION DETAIL.
7. INSTALL PRESSURE REGULATOR ON ROOF. ROUTE 1 1/2" LOW PRESSURE GAS IN THRU ROOF TO EQUIPMENT.

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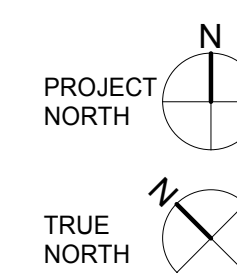
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PLUMBING OVERALL ROOF PLAN

SHEET NO. _____

P3.0





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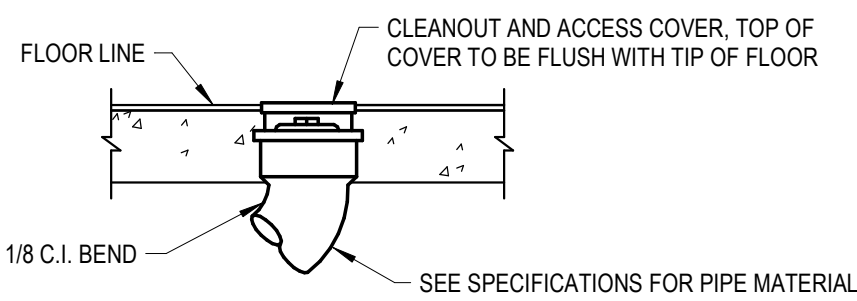
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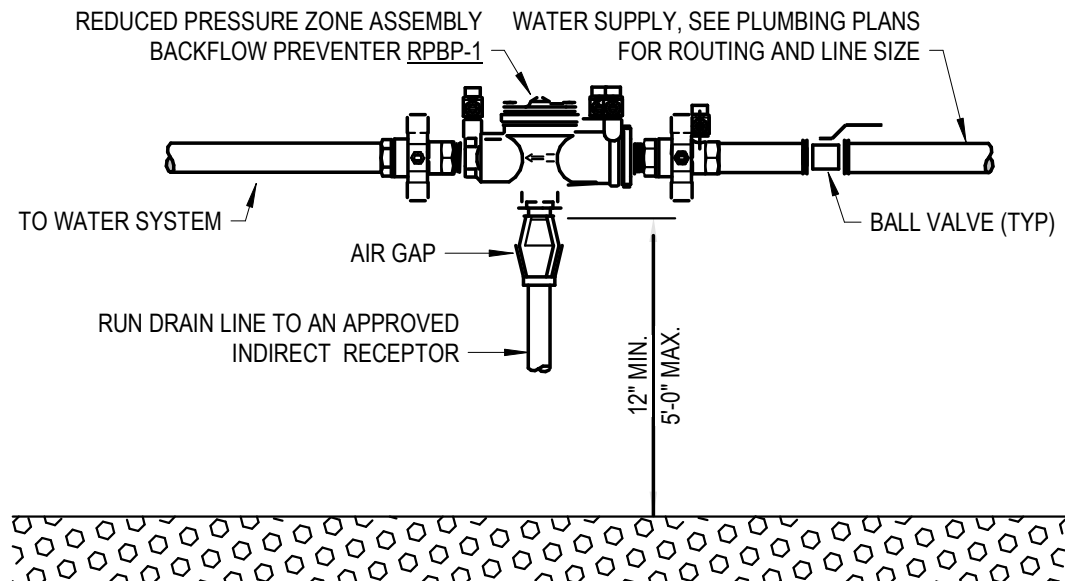
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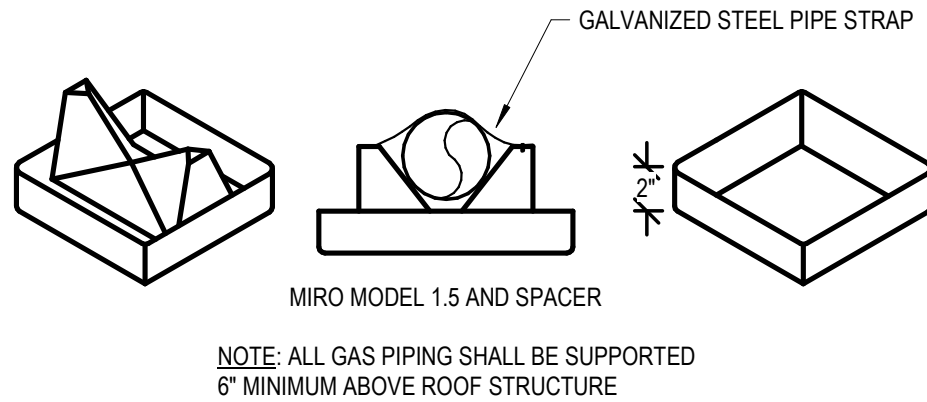


NOTE:
CLEANOUTS SHALL BE PROVIDED AT EACH HORIZONTAL DRAINAGE PIPE AT ITS UPPER
TERMINAL, AND EACH RUN OF PIPING WHICH IS MORE THAN 100 FEET, AND SHALL BE
PROVIDED FOR EACH 100 FEET DEVELOPMENT, OR FRACTION THEREOF OF SUCH
PIPING. AN ADDITIONAL CLEANOUT SHALL BE PROVIDED FOR EACH AGGREGATE
HORIZONTAL CHANGE OF DIRECTION EXCEEDING ONE HUNDRED THIRTY-FIVE DEGREES,
PER APPLICABLE PLUMBING CODE. THIS SHALL BE PROVIDED REGARDLESS OF WHAT IS
SHOWN ON THE DRAWINGS.

1 FLOOR CLEANOUT (FCO) DETAIL
NTS



2 REDUCED PRESSURE BACKFLOW PREVENTER DETAIL
NTS



APPROVED PIPE SUPPORT SYSTEMS:


- MIRO MODEL 1.5 WITH SPACERS
- ADVANCED SUPPORT PRODUCTS
- VERSABLOCK BY FREEDOM INC

PIPE SUPPORT REQUIREMENTS	
SIZE OF PIPE	SUPPORT REQUIRED
1/2"	6" O.C.
3/4" - 1"	8" O.C.
1-1/4" OR LARGER	10" O.C.

3 ROOF MOUNTED PIPING SUPPORT DETAIL
NTS

EQUIPMENT CONNECTION NOTES:

1. INSTALL FLEX CONNECTION AT ALL ROOF TOP UNITS WHICH HAVE SPRING ISOLATION CURBS (36" MAXIMUM)
2. INSTALL SOLID PIPE CONNECTION TO ALL ROOF TOP UNITS WHICH DO NOT HAVE SPRING ISOLATION CURBS
3. PAINT PIPE WITH RUST RESISTANT PRIMER, RED OR GRAY. SHERWIN WILLIAMS PRO INDUSTRIAL DTM OR APPROVED EQUAL.

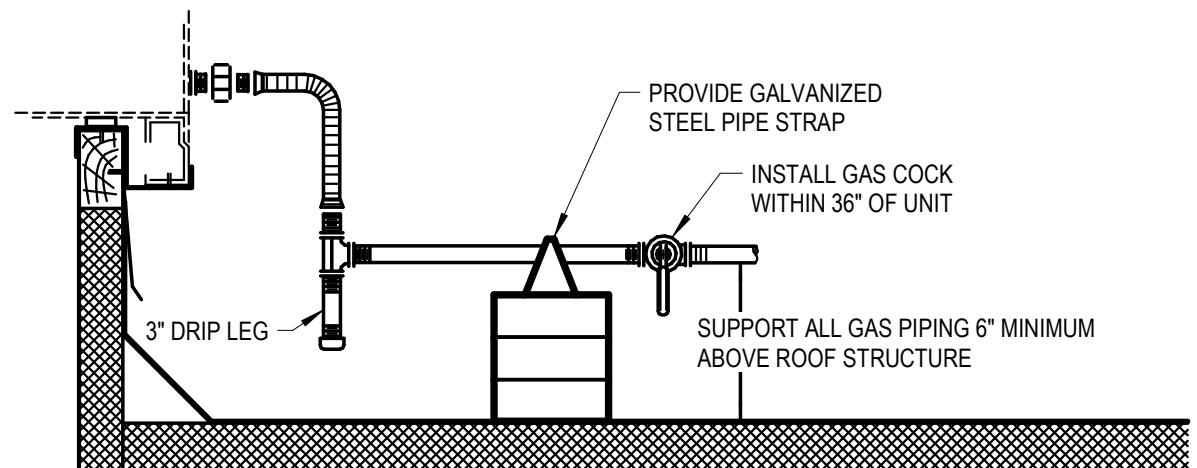

APPROVED PIPE SUPPORT SYSTEMS:


- MIRO MODEL 1.5 WITH SPACERS
- ADVANCED SUPPORT PRODUCTS
- VERSABLOCK BY FREEDOM INC

PIPE SUPPORT REQUIREMENTS	
SIZE OF PIPE	SUPPORT REQUIRED
1/2"	6" O.C.
3/4" - 1"	8" O.C.
1-1/4" OR LARGER	10" O.C.


4 GAS EQUIPMENT CONNECTION DETAIL (ROOFTOP UNIT)
NTS

VENTING NOTES:


1. VENT REGULATORS PER MANUFACTURER'S AND LOCAL GAS COMPANY'S REQUIREMENTS.
2. DO NOT REDUCE THE VENT PIPE SIZE FROM THE REGULATOR.
3. TO LIMIT THE CONSEQUENCES OF RAIN, SNOW OR DEBRIS GETTING INTO THE VENT, ALWAYS TURN THE OUTLET OF THE VENT DOWN AND ABOVE POTENTIAL WATER OR SNOW LINES.
4. PROVIDE A BUG SCREEN ON THE VENT OUTLET TO DETECT INSECTS FROM NESTING IN THE LINE. NEVER PAINT OVER THE BUG SCREEN.
5. A VENT LINE PROTECTOR MAY BE USED IN OUTDOOR APPLICATIONS TO PREVENT ENTRY OF WATER, INSECTS OR OTHER FOREIGN MATERIALS THAT COULD CAUSE BLOCKAGE.
6. VENT MUST BE PIPED A MINIMUM 3 FEET ABOVE OR 10 FEET AWAY FROM ALL FRESH AIR INTAKES.
7. VENTS SHALL RUN INDEPENDENTLY TO THE OUTDOORS AND SHALL SERVE ONLY A SINGLE DEVICE VENT.
8. REGULATOR VENT PIPING SHALL NOT EXCEED THE LENGTH SPECIFIED IN THE REGULATOR MANUFACTURER'S INSTRUCTIONS.

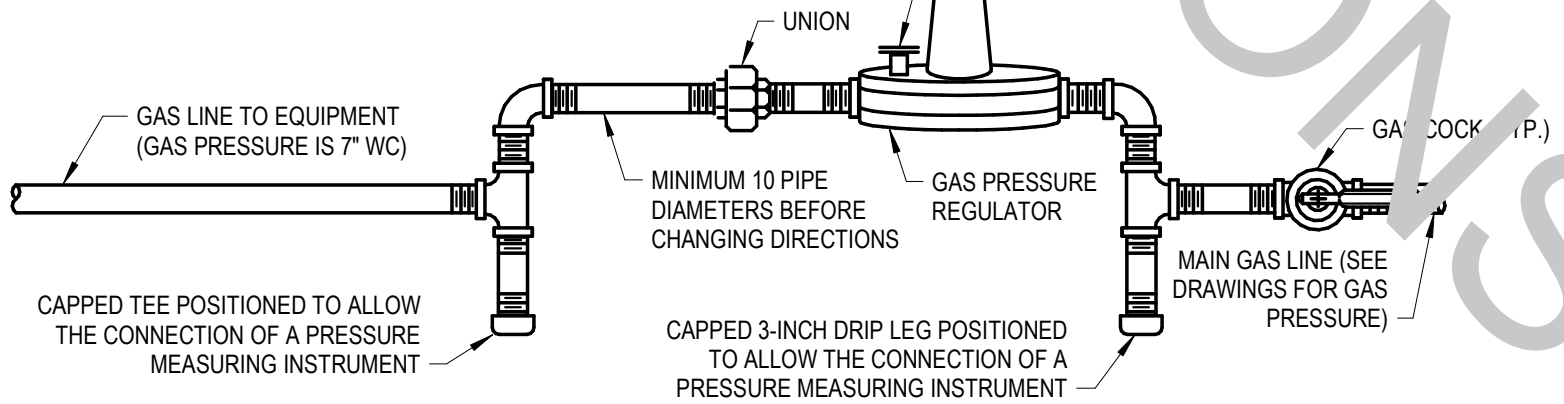

5 GAS PRESSURE REGULATOR DETAIL
NTS

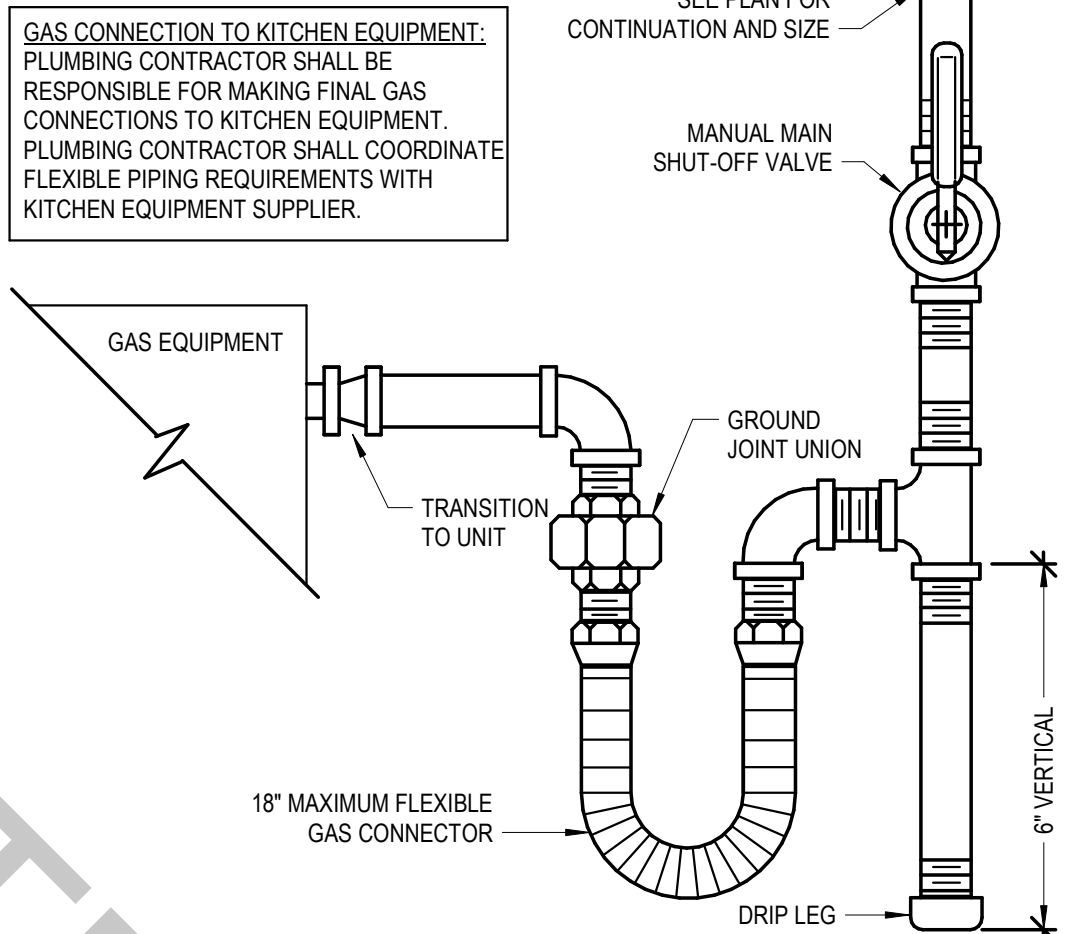


6 GAS EQUIPMENT CONNECTION DETAIL
NTS

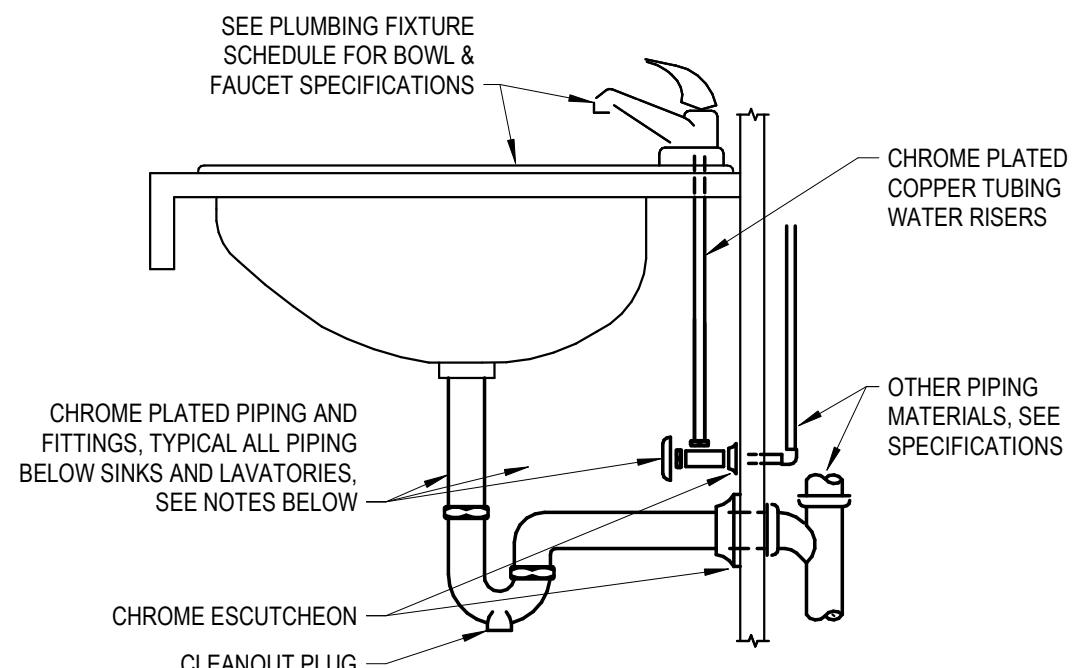


- NOTES:
- A. INTERIOR EXPOSED PIPE, VALVES AND FIXTURE TRIM, INCLUDING TRIM BEHIND CASEWORK DOORS SHALL BE CHROME PLATED.
 - B. ALL PIPING PENETRATIONS THROUGH FINISHED WALLS SHALL BE PROVIDED WITH CHROME ESCUTCHEONS.
 - C. ALL SINK TRAPS SHALL BE PROVIDED WITH A CLEANOUT PLUG IN THE BOTTOM OF THE TRAP.
 - D. ALL PLUMBING FIXTURES SHALL BE CAULKED AND SEALED TO SURROUNDING SURFACES.

7 SINK/LAVATORY TAILPIECE & TRAP DETAIL
NTS

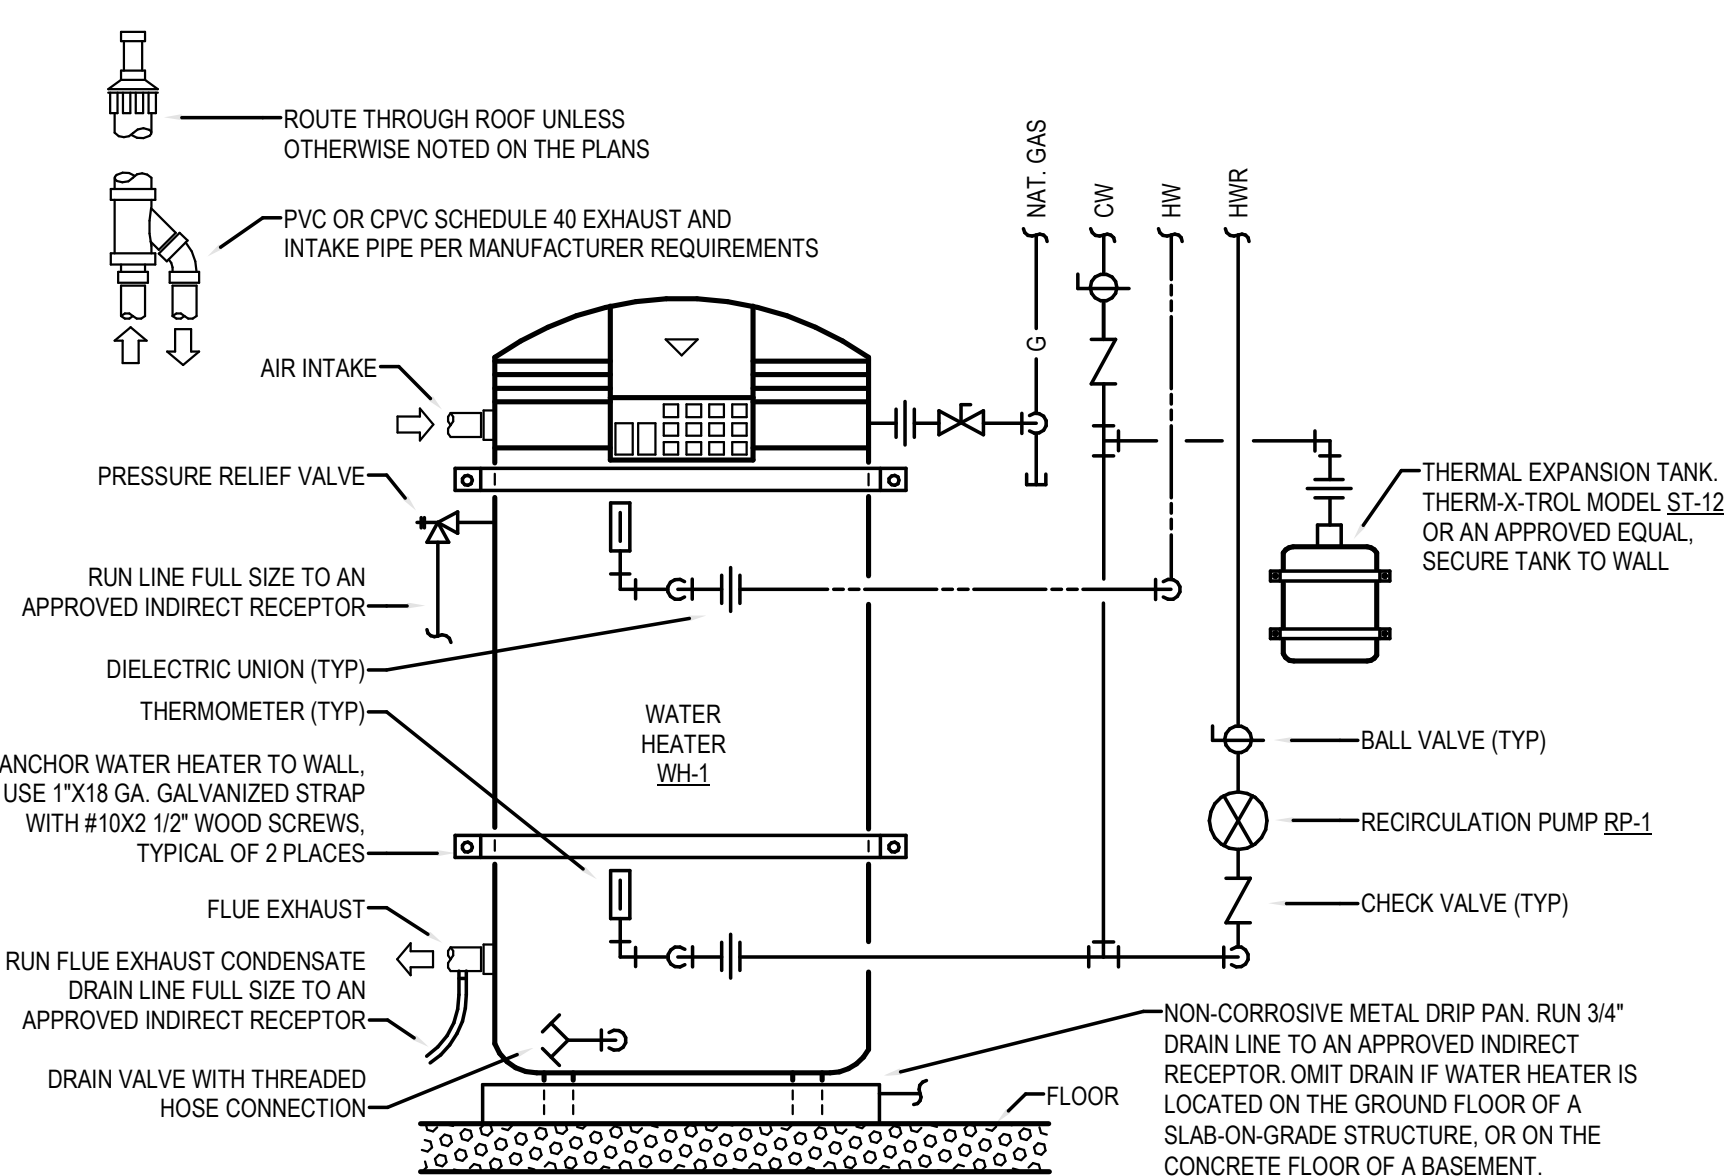

8 WATER HEATER DETAIL (GAS - HIGH EFFICIENT)
NTS

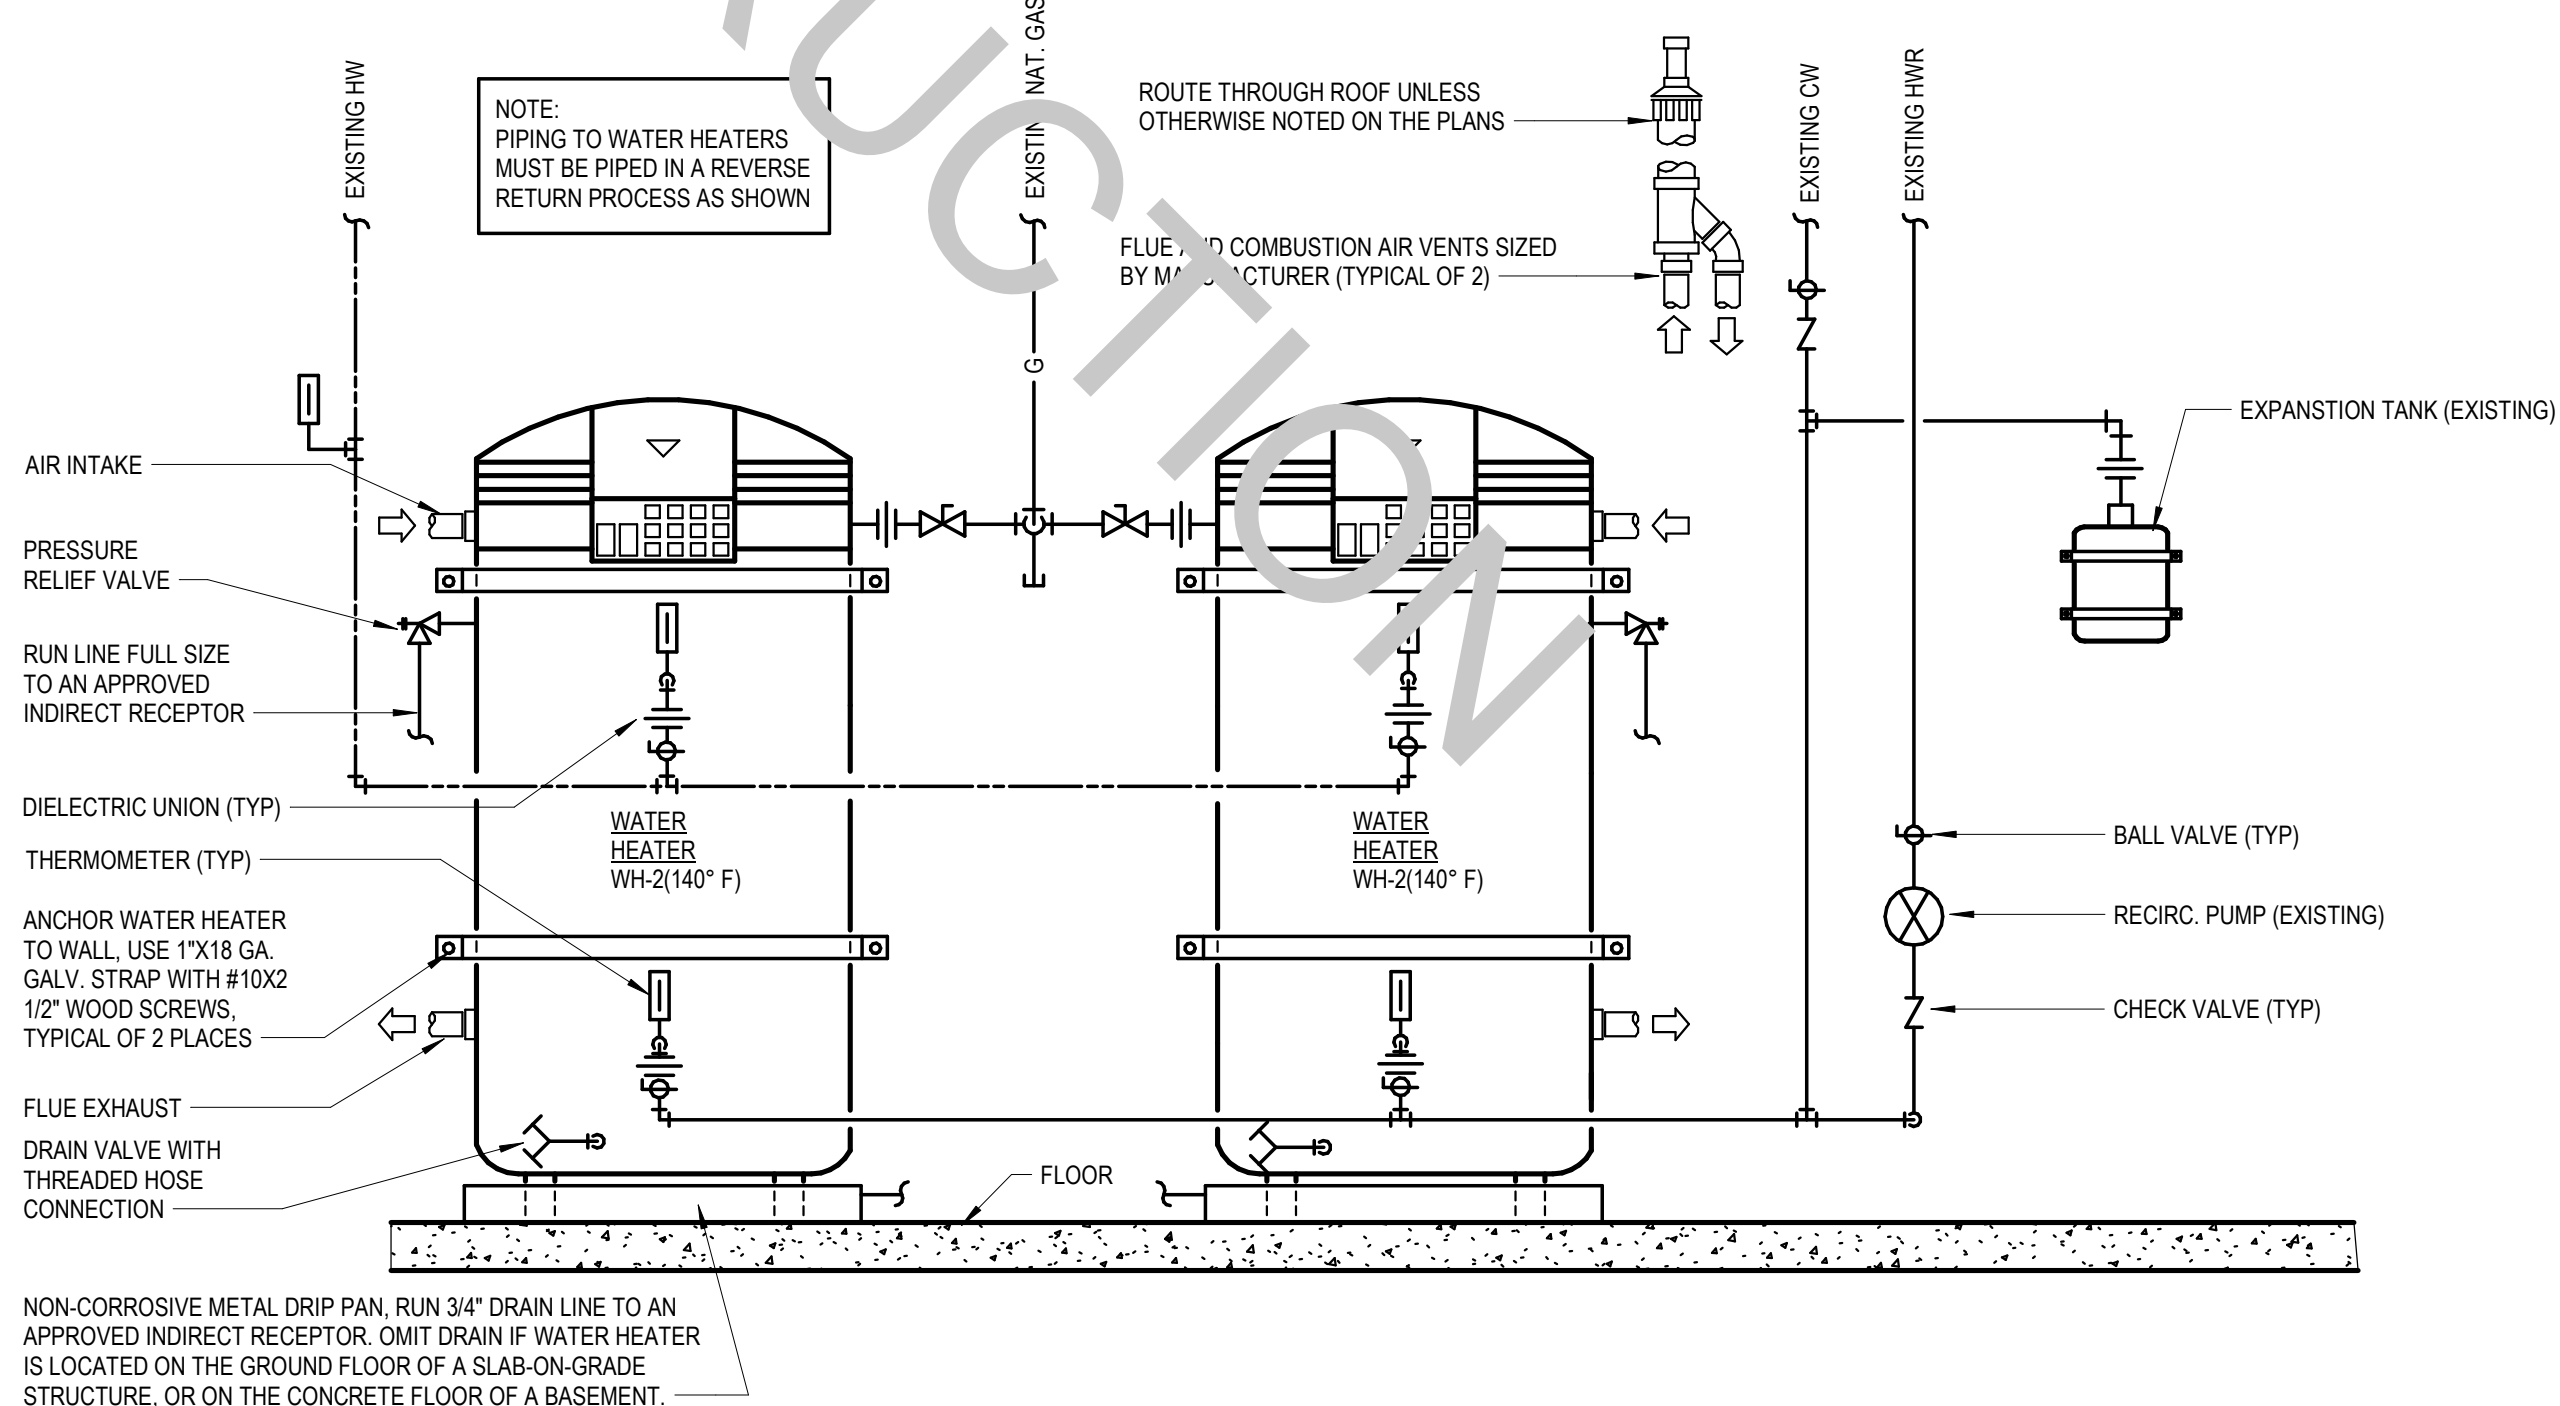

9 HIGH EFFICIENCY GAS WATER HEATER PIPING DETAIL
NTS

DPW 21535 - IDJC
LAUNDRY &
KITCHEN
REMODEL - JCCN

IDAHO DPW - IDJC

CONSULTANT:

MRK DATE DESCRIPTION

JOB NO.: 22003.01
DATE: 08/12/22
DRAWN BY: AH
CHECKED BY: BC

PHASE: 100% DESIGN
DEVELOPMENT

PLUMBING
DETAILS

SHEET NO.

P4.0



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PLUMBING FIXTURE SCHEDULE

SYMBOL	FIXTURE DESCRIPTION	CONNECTION SIZE					MANUFACTURER / MODEL NUMBER / DESCRIPTION / ADDITIONAL COMMENTS
		WASTE	VENT	TRAP	CW	HW	
ET-1	EXPANSION TANK	--	--	--	3/4"	--	AMTROL THERMOSTAT-CONTROLLED, OR APPROVED EQUAL, NON-ASME SERIES THERMAL EXPANSION ABSORBER, ASME-MICROBALL VALVE, AND 5 YEAR WARRANTY.
EYE-1	EMERGENCY EYE WASH (FAUCET MOUNTED)	--	--	--	--	--	1. WIS MODEL 7600 AXION EYEPOD FAUCET-MOUNTED EYEWASH WITH INTERNAL THERMOSTATIC SHUT-OFF VALVE. EYEWASH IS ACTIVATED BY ROTATING HEAD 180° IN EITHER DIRECTION. EYEWASH COMES WITH A STANDARD 1/2" NPT 1/4" CONNECTION. 2. STAINLESS STEEL FAUCET CONNECTION, ALONG WITH FOUR ADDITIONAL ADAPTERS. PROVIDED WITH OPTIONAL 1.0 GPM LAMINAR FLOW FAUCET OUTLET AND UNIVERSAL EYEWASH SIGN. ANSI Z35.1 COMPLIANT.
FCO	FLOOR CLEANOUT	SEE PLANS	--	--	--	--	JAY R. SMITH 4020 SERIES WITH ADJUSTABLE, ROUND NICKEL BRONZE TOP AND ABS PLUG.
FD-1	FLOOR DRAIN (PVC BODY) (CONCRETE FLOOR)	2"	2"	2"	--	--	SIOUX CHIEF SERIES NUMBER 832-2P. PVC CONSTRUCTION LEVELING FLOOR DRAIN, NO-HUB OUTLET, 6-1/2" ROUND, ADJUSTABLE NICKEL BRONZE STRAINER AND TRAP PRIMER PORT. INSTALL TOP OF DRAIN 1/8" BELOW FINISH FLOOR AND CORK EDGE.
FS-1	FLOOR SINK (6" DEEP) (HALF GRATE, FOOT TRAFFIC RATED) COMMERCIAL KITCHEN, BAR, OR PROCESSING LOCATIONS	2"	2"	2"	--	--	JAY R. SMITH FIGURE NUMBER 300L-12 STAINLESS STEEL RECEPTOR, DOME STRAINER AND GRATE WITH TRAP PRIMER. INSTALL TOP OF SINK 1/8" BELOW FINISH FLOOR AND CORK EDGE.
LAV-1	LAVATORY (WALL MOUNTED) (ADA COMPLIANT)	1 1/2"	1 1/2"	1 1/4"	1/2"	1/2"	KOHLER KINGSTON MODEL K-2005. VITREOUS CHINA, WALL MOUNTED. HOLES ON 4" CENTERS, AND GRID STRAINER. KOHLER CORALAIS MODEL K-15198. 4-1/2" LONG SINGLE LEVER FAUCET WITH 0.5 GPM AERATOR. PROVIDE WITH JAY R. SMITH FIGURE NUMBER 0700-1 SUPPORT WITH CONCEALED ARMS AND WATTS SERIES LFUSG-B LEAD-FREE, THERMOSTATIC MIXING VALVE, ASSE STANDARD 1070 LISTED, BRONZE BODY, INTEGRAL CHECK VALVES, AND SELECTABLE TEMPERATURE RANGE FROM 80°F TO 120°F. PROVIDE WITH LS-1 LAV SHIELD.
LAV-2	LAVATORY (WALL MOUNTED) (ADA COMPLIANT)	1 1/2"	1 1/2"	1 1/4"	1/2"	1/2"	KOHLER KINGSTON MODEL K-2005. VITREOUS CHINA, WALL MOUNTED. HOLES ON 4" CENTERS, AND GRID STRAINER. KOHLER CORALAIS MODEL K-15198. 4-1/2" LONG SINGLE LEVER FAUCET WITH 0.5 GPM AERATOR. AND WATTS SERIES LFUSG-B LEAD-FREE, THERMOSTATIC MIXING VALVE, ASSE STANDARD 1070 LISTED, BRONZE BODY, INTEGRAL CHECK VALVES, AND SELECTABLE TEMPERATURE RANGE FROM 80°F TO 120°F. PROVIDE WITH LS-1 LAV SHIELD. VERIFY EXISTING MODEL PRIOR TO ORDERING NEW FIXTURE TO ENSURE NEW FIXTURE WILL MOUNT TO EXISTING WALL SUPPORT.
LS-1	LAVATORY SHIELD (WALL MOUNTED SHIELD FOR CONCEALING PIPING AND VALVES)	--	--	--	--	--	TRUEBRO "LAV SHIELD" ADA COMPLIANT, TOTAL ENCLOSURE. SINGLE-PIECE CONSTRUCTION, SLOAN OPTISHIELD ETF-529, OR APPROVED EQUAL.
RP-1	RECIRCULATION PUMP (HOT WATER RETURN SYSTEM) (MEDIUM SIZED SYSTEM)	--	--	--	--	3/4"	BELL AND GOSSETT BRONZE MODEL NBF-22, 115 VOLT, 0.8 AMPS, 92 WATTS, AND SHALL PROVIDE 7 GPM AT 10 FEET HEAD. INCLUDE 7-DAY PROGRAMMABLE ELECTRONIC TIME CLOCK WITH BATTERY BACKUP, INTERMATIC MODEL GM40VE-RD89. APPROVED ALTERNATE: ARMSTRONG, TACO, GRUNDFOS.
RBPB-1	REDUCED PRESSURE BACKFLOW PREVENTER	INDIRECT			--	--	WATTS SERIES LF099 LEAD-FREE REDUCED PRESSURE ZONE ASSEMBLY WITH QUARTER-TURN BALL VALVES, STRAINER, AND AIR GAP. CAST COPPER BODY CONSTRUCTION - 1/2" THRU 2". PROVIDE SERIES 957 FOR SIZES 2 1/2" THRU 10". SEE NOTE 6.
S-1	SINK - KITCHEN HANDWASH (19" X 12" X 6") (WALL MOUNTED)	2"	1 1/2"	1 1/2"	1/2"	1/2"	ELKAY HANDWASH SINK MODEL CHS1716C. 6" DEEP, WALL MOUNTED, STAINLESS STEEL SINK. PROVIDE AND INSTALL ELKAY MODEL LK9400N42H HIGH GOOSENECK SPOUT FAUCET WITH 8" CENTERS AND LEVER HANDLES. ELKAY MODEL LK8 GRID STRAINER AND TAILPIECE. ELKAY MODEL LK500 P-TRAP WITH CLEANOUT PLUG, AND WATTS SERIES LFUSG-B LEAD-FREE, THERMOSTATIC MIXING VALVE, ASSE STANDARD 1070 LISTED, BRONZE BODY, INTEGRAL CHECK VALVES, AND SELECTABLE TEMPERATURE RANGE FROM 80°F TO 120°F. PROVIDE WITH FAUCET-MOUNTED EYEWASH EYE-1. PROVIDE WITH FLOOR MOUNTED FOOT PEDALS ELKAY MODEL LK399A FOR FOOT OPERATION OF SINK.
S-2	SINK - BREAKROOM SINK (14" X 18 1/2" X 5 3/8") (UNDERMOUNT)	2"	1 1/2"	1 1/2"	1/2"	1/2"	ELKAY LUSTERTONE CLASSIC MODEL ELUHAD11655PD. 5 3/8" DEEP, UNDERMOUNT, STAINLESS STEEL SINK. PROVIDE AND INSTALL ELKAY MODEL LK3000CR SINGLE LEVER CHROME FAUCET WITH SWING SPOUT, ELKAY MODEL LK35 STAINLESS STEEL STRAINER BASKET AND TAILPIECE. AND WATTS SERIES LFUSG-B LEAD-FREE, THERMOSTATIC MIXING VALVE, ASSE STANDARD 1070 LISTED, BRONZE BODY, INTEGRAL CHECK VALVES, AND SELECTABLE TEMPERATURE RANGE FROM 80°F TO 120°F.
S-3	SINK - EXAM SINK (14" X 18 1/2" X 5 3/8") (MOTION SENSOR) (UNDERMOUNT)	2"	1 1/2"	1 1/2"	1/2"	1/2"	ELKAY LUSTERTONE CLASSIC MODEL ELUHAD11655PD. 5 3/8" DEEP, UNDERMOUNT, STAINLESS STEEL SINK. PROVIDE AND INSTALL ELKAY MODEL LK3000CR SINGLE LEVER CHROME FAUCET WITH SWING SPOUT AND HOSE SPRAY. ELKAY MODEL LK35 STAINLESS STEEL STRAINER BASKET AND TAILPIECE. AND WATTS SERIES LFUSG-B LEAD-FREE, THERMOSTATIC MIXING VALVE, ASSE STANDARD 1070 LISTED, BRONZE BODY, INTEGRAL CHECK VALVES, AND SELECTABLE TEMPERATURE RANGE FROM 80°F TO 120°F. PROVIDE WITH FAUCET-MOUNTED EYEWASH EYE-1.
SS-1	SERVICE SINK (24" X 24" X 10") (FLOOR MOUNTED)	3"	2"	3"	1/2"	1/2"	ACORN TERRAZZO-WARE MODEL TRH-242410; PROVIDE AND INSTALL WITH MODEL KFC CHROME UTILITY FAUCET, STAINLESS STEEL BUMPER GUARD, DRAIN GASKET, 3/8" HOSE AND WALL HANGER, MCP HANGER, AND (2) STAINLESS STEEL WALL GUARDS. MOUNT FAUCET 36" AFF.
TP-1	TRAP PRIMER (PRESSURE ACTIVATED) (1 TO 4 TRAPS)	--	--	--	1/2"	--	PRECISION PLUMBING PRODUCTS MODEL CPO-500 WITH DU DISTRIBUTION UNIT IF REQUIRED FOR SERVING MORE THAN ONE TRAP. APPROVED ALTERNATES: MIFAB, SIOUX CHIEF, SLOAN, AND ZURN
TP-1	TRAP PRIMER (LAVATORY TAILPIECE PRIMER) (1 TRAP)	--	--	--	1/2"	--	DEARBORN BRASS 1-1/2" TRAP PRIMER TAILPIECE WITH COMPRESSION CONNECTION.
US-1	UTILITY SINK (23" X 21" X 13") (FLOOR MOUNTED)	2"	1 1/2"	1 1/2"	1/2"	1/2"	FIAT MOLDED STONE MODEL FL-1 FLOOR MOUNTED SINK WITH EASY LEVELING LEGS, DRAIN ASSEMBLY AND STOPPER WITH FIAT A1 CHROME FAUCET, DECK MOUNTED, 4" O.C. WITH 4" WRISTBLADES, 6-3/4" SWING SPOUT, AND WATTS SERIES LFUSG-B LF, THERMOSTATIC MIXING VALVE, ASSE STANDARD 1070 LISTED, BRONZE BODY, INTEGRAL CHECK VALVES, AND SELECTABLE TEMPERATURE RANGE FROM 80°F TO 120°F.
WC-1	WATER CLOSET (17-1/2" SEAT HEIGHT) (FLUSH VALVE) (FLOOR MOUNTED) (COMFORT HEIGHT / ADA COMPLIANT)	4"	2"	INT.	1"	--	KOHLER HIGHCLIFF ULTRA MODEL K-96057 FLOOR MOUNTED WITH ELONGATED BOWL. KOHLER LUSTRA MODEL K-4666-C ELONGATED OPEN FRONT SEAT WITH HINGE. SLOAN REGAL MODEL 111-1.6 FLUSHMOTOR, 1.6 GPF.
WCO	WALL CLEANOUT	SEE PLANS	--	--	--	--	JAY R. SMITH 4427T SERIES WITH CAST BRONZE TAPER THREAD PLUG, STAINLESS STEEL ROUND COVER, AND A STAINLESS STEEL VANDAL PROOF SCREW.
WH-1	WATER HEATER (NOMINAL 120 GALLON) (NATURAL GAS - HIGH EFFICIENCY)	--	--	--	SEE PLANS	SEE PLANS	BRADFORD WHITE MODEL EF-120T-400E-3N, 399 MBH INPUT, 110V/1,0, 1.8 AMPS, 33" DIAMETER, 78" TALL WITH SIDE CONNECTIONS. PROVIDE WITH PVC CONCENTRIC INTAKE/VENT KIT AND SEISMIC STRAP. PROVIDE WATER HEATER WITH HEAT TRAP.
WH-2	WATER HEATER (NOMINAL 100 GALLON) (NATURAL GAS - HIGH EFFICIENCY)	--	--	--	SEE PLANS	SEE PLANS	BRADFORD WHITE MODEL EF-100T-199E-3N, 199 MBH INPUT, 110V/1,0, 1.8 AMPS, 28" DIAMETER, 78" TALL WITH SIDE CONNECTIONS. PROVIDE WITH PVC CONCENTRIC INTAKE/VENT KIT AND SEISMIC STRAP. PROVIDE WATER HEATER WITH HEAT TRAP.
WS-1	WATER SOFTENER	INDIRECT			1"	--	KINETICO ESSENTIAL SERIES, ESSENTIAL GOLD, 9.5 G

NOTES:	
1.	ALL ADA COMPLIANT FIXTURES MUST COMPLY WITH ICC/ANSI A117.1. SEE ARCHITECTURAL PLANS FOR HANDICAPPED FIXTURE DESIGNATIONS, LOCATIONS, CLEARANCES, AND MOUNTING HEIGHTS.
2.	ALL EXPOSED HW PIPING, CW PIPING, AND DRAIN LINES BENEATH ALL LAVATORIES AND ALL ADA COMPLIANT SINKS MUST BE INSULATED TO PREVENT INJURY. REFER TO ARCHITECTURAL PLANS. INSULATE WITH MOLDED CLOSED CELL VINYL INSULATION - TRUEBRO, PLUMBEREX, OR EQUAL.
3.	PROVIDE P-TRAP PRIMERS FOR ALL FLOOR DRAINS AND FLOOR SINKS (NOT ALL TRAP PRIMERS ARE INDICATED ON PLANS - REFERENCE DETAILS FOR ADDITIONAL INFORMATION). PROVIDE A BALL TYPE SHUT-OFF VALVE UPSTREAM OF PRIMER VALVE. SEE SPECIFICATIONS.
4.	SEE SPECIFICATIONS FOR ALTERNATE APPROVED MANUFACTURERS.
5.	HIGH EFFICIENCY WATER HEATERS: PROVIDE WITH CONDENSATE NEUTRALIZATION KIT BY JIM BOILER WORKS MODEL JM (OR EQUAL), SIZED PER EQUIPMENT CAPACITY.
6.	BACKFLOW PREVENTION: THIS BUILDING IS PROVIDED WITH A REDUCED PRESSURE BACKFLOW PREVENTER (<u>RPBP</u>) ON THE MAIN WATER SERVICE AND ON THE FOLLOWING PIECES OF EQUIPMENT: WASHER HOT AND COLD WATER STEAM KETTLE HOT AND COLD WATER

KITCHEN PLUMBING EQUIPMENT SCHEDULE

SYMBOL	EQUIPMENT REFERENCE	FIXTURE DESCRIPTION	CONNECTION SIZE						MANUFACTURER / MODEL NUMBER / DESCRIPTION / ADDITIONAL COMMENTS	REMARKS
			WASTE	VENT	TRAP	CW	HW	GAS		
K-1	--	RANGE	--	--	--	--	--	3/4"	PROVIDED BY KITCHEN EQUIPMENT CONTRACTOR ROUGH-IN & INSTALLED BY PLUMBING CONTRACTOR. SEE KITCHEN EQUIPMENT PLANS FOR DETAILS AND REQUIREMENTS OF KITCHEN EQUIPMENT.	--
K-2	--	STEAM KETTLE	INDIRECT TO FLOOR SINK			1/2"	1/2"	3/4"	PROVIDED BY KITCHEN EQUIPMENT CONTRACTOR ROUGH-IN & INSTALLED BY PLUMBING CONTRACTOR. SEE KITCHEN EQUIPMENT PLANS FOR DETAILS AND REQUIREMENTS OF KITCHEN EQUIPMENT.	1
K-3	--	EXISTING OVEN	--	--	--	--	--	3/4"	PROVIDED BY KITCHEN EQUIPMENT CONTRACTOR ROUGH-IN & INSTALLED BY PLUMBING CONTRACTOR. SEE KITCHEN EQUIPMENT PLANS FOR DETAILS AND REQUIREMENTS OF KITCHEN EQUIPMENT.	--

NOTES:

1. PROVIDE WITH LINE-SIZED REDUCED PRESSURE BACKFLOW PREVENTER

GAS SIZING CHART

SYMBOL	INPUT (MBH)	RUNOUT SIZE (2PSI) (INCHES)	EQUIPMENT CONNECTION SIZES (7" WC) (INCHES)
<u>MAU-1</u>	176.2	3/4	1 1/2
<u>WH-1</u>	399	1 1/2	3/4
DRYER	135	3/4	1/2
DRYER	135	3/4	1/2
DRYER	135	3/4	1/2
TOTAL	980.2	EQUIVALENT LENGTH = 400 FT PRESSURE = 2 PSI MAIN SIZE = 1 1/2"	

NOTE: GAS LINES TO EQUIPMENT ARE AS NOTED IN SCHEDULE ABOVE. ROUTE NOTED (2PSI) GAS LINE TO GAS EQUIPMENT. PROVIDE GAS COCK AND PRESSURE REGULATOR (2 PSI-7" WC) SIZED FOR GAS LOAD AT EACH PIECE OF EQUIPMENT. VENT TO ATMOSPHERE PER MANUFACTURERS RECOMMENDATIONS. ROUTE NOTED (7" WC) GAS LINE TO GAS FIRED EQUIPMENT WITH GAS COCK AND FLEX CONNECTOR AT UNIT. SEE GAS CONNECTION DETAILS.

LOMBARD
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KITCHEN
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CONSULTANT

MRK	DATE	DESCRIPTION
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JOB NO.: 22003.0
DATE: 08/12/2022
DRAWN BY: A
CHECKED BY: B

PHASE: **100% DESIGN DEVELOPMENT**

PLUMBING SCHEDULES

SHEET NO.

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